JAMIE WHITEHOUSE, AICP DIRECTOR OF PLANNING & ZONING (302) 855-7878 T (302) 854-5079 F jamie.whitehouse@sussexcountyde.gov





PLEASE NOTE

This paperless packet is published on the County's website for convenience purposes, and only includes information received up to the close of business on the day before a public hearing. Documents received after this, or documents submitted during the public hearing are not uploaded to the Paperless Packet. The legal record is the paper record maintained in the Offices of the Planning & Zoning Department.



JAMIE WHITEHOUSE, AICP, MRTPI DIRECTOR OF PLANNING & ZONING (302) 855-7878 T jamie.whitehouse@sussexcountyde.gov



Sussex County DELAWARE sussexcountyde.gov

HW

Memorandum

To: Sussex County Planning Commission Members

From: Jamie Whitehouse, AICP, Director, Department of Planning & Zoning; Jenny Norwood, Planning and Zoning Manager; Lauren DeVore, AICP Planner III; Michael Lowrey, Planner III; Chase Phillips, Planner II; Christin Scott, Planner II; Elliott Young, Planner I & Jesse Lindenberg, Planner I

CC: Vince Robertson, Assistant County Attorney

Date: July 18th, 2022

RE: Other Business for the July 28th, 2022, Planning Commission Meeting

This memo provides background for the Planning Commission to consider as a part of the Other Business to be reviewed during the July 28th, 2022, Meeting of the Planning & Zoning Commission.

Inland Bays (S-22-28 & C/U 2259)

Preliminary Site Plan & Landscape Pan

This is a Preliminary Site Plan and Landscape Plan for the construction of thirty (30) single-family detached condominiums, landscaping, and amenities to include a pool house, inground pool, community mail center, and related site improvements. The improvements are to be located on the north side of Fred Hudson Road (S.C.R. 360), approximately 0.25 mile east of Cedar Neck Road (S.C.R. 357). A Conditional Use (C/U 2259) to allow for multi-family dwelling units was approved by Sussex County Council on December 7, 2021 subject to nineteen (19) Conditions of Approval via Ordinance No. 2817. The Preliminary Site Plan complies with the Sussex County Zoning Codes and all Conditions of Approval. Tax Parcel: 134-13.00-72.02. Zoning: MR (Medium-Density Residential District). Staff are awaiting agency approvals; therefore, this plan can be considered for preliminary approval with final approval to be by staff.

Indian River Solar Farm (F.K.A. Broom Solar) (C/U 2288)

Preliminary Site Plan

This is a Preliminary Site Plan for the construction of a solar array farm and other site improvements to be located on the north side of Frankford School Road (S.C.R. 92). The Planning and Zoning Commission at their February 27, 2022, meeting approved CU 2288. The Preliminary Site Plan complies with the Sussex County Zoning Code and all Conditions of Approval. Tax Parcel: 533-5.00-47.00. Zoning: AR-1 (Agricultural Residential Zoning District). Staff are awaiting agency approvals.

<u>Lewes Farmer's Market</u>
KS

Revised Final Site Plan

This is a Revised Final Site Plan for the addition of eight (8) shipping containers to be utilized as retail storage spaces. The revision proposes a reduction of seven (7) parking spaces with one (1) storage unit to be kept on a concrete pad behind the building. With the proposed reduction, the plan remains consistent with parking requirements of Chapter 115 as parking exceeds the minimum requirement of 81 spaces. 98 remain. The proposal is subject to any applicable approvals from other agencies. The Revised Final Site Plan complies with the Sussex County Zoning Code. Tax Parcel: 334-6.00-497.03. Zoning: C-1 (General Commercial Zoning District). Staff are awaiting agency approvals.



Lands of Kenneth Schroder & Carolyn Patterson

Minor off a 50-foot easement and a 20-foot easement


This is a Preliminary Minor Subdivision Plan for the subdivision of 20.747 acre +/- parcel of land into three (3) lots and residual lands off a 50-foot easement and a 20-foot easement. Proposed Lot 1 consists of 5.006 acres +/-; Proposed Lot 2 consists of 11.317 acres +/-; Proposed Lot 3 consists of 2.262 acres +/-; and the residual lot consists of 2.162 acres +/-. The property is located on the south side of Johnson Lane. The Preliminary Minor Subdivision Plan complies with the Sussex County Zoning and Subdivision Codes. Zoning: AR-1 (Agricultural Residential District). Tax Parcel: 234-9.00-47.00.

Lands of Yong J. Park, Je Y. Kim & Soon J. Kim

Minor Subdivision off a 50-ft Easement

This is a Minor Subdivision Plan for the subdivision of 6.166 acre +/- parcel of land into one (1) lot and residual lands off a 50-foot ingress/egress access easement. Proposed Lot 1 consists of 1.131 acres and the residual lands consist of 5.035 acres +/-. The property is located on the southeast side of Mount Pleasant Road (S.C.R. 493). The Minor Subdivision Plan complies with the Sussex County Zoning and Subdivision Codes. Zoning: AR-1 (Agricultural Residential District). Tax Parcel: 432-7.00-2.00. Staff are in receipt of all agency approvals.

KS

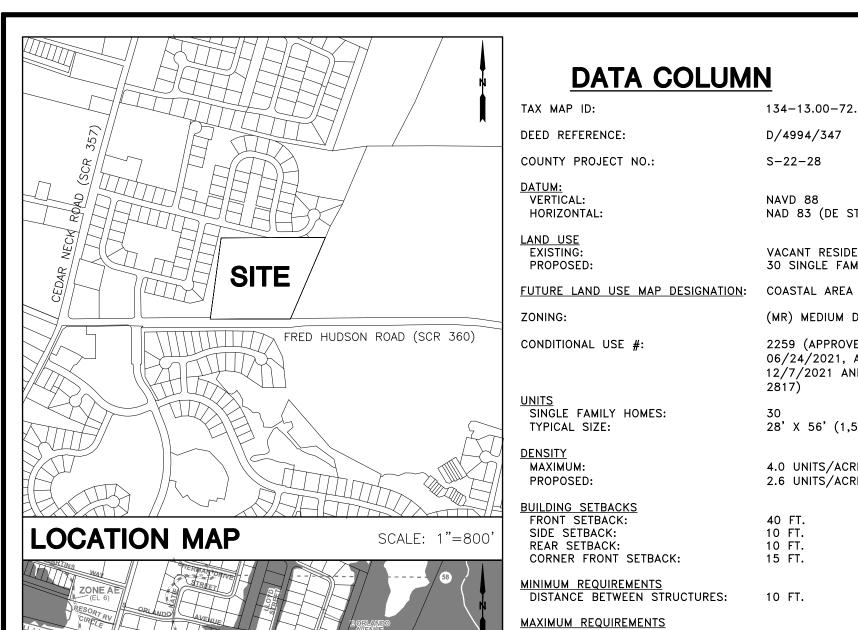

RIGHT OF WAY DEDICATION: NET DEVELOPMENT AREA: POOL: PARKING: TOTAL: **WOODLANDS:** TOTAL REMAINING **OPEN SPACE:**

SCALE: 1"=800 FEMA PANEL 10005C0512K, DATED MARCH 16, 2015 FRED HUDSON ROAD (SCR 360)

AsA: ASKECKSY LOAMY SAND; 0 TO 2 PERCENT SLOPES (B/D) DnA: DOWNER LOAMY SAND; 0 TO 2 PERCENT SLOPES (B) IeA: INGLESIDE LOAMY SAND; 0 TO 2 PERCENT SLOPES (B)

KsA: KLEJ LOAMY SAND; 0 TO 2 PERCENT SLOPES (C)

MuA: MULLICA-BERRYLAND COMPLEX; 0 TO 2 PERCENT SLOPES (B/D)


SOILS MAP

FRED HUDSON ROAD (SUSSEX ROAD 360) FUNCTIONAL CLASSIFICATION - MAJOR CÓLLECTOR AADT (2019 DELAWARE VEHICLE VOLUME SUMMARY) 10 YR PROJECTED AADT = 1.16 X 12,590 10 YR PROJECTED AADT + SITE ADT E OF SITE (168) = 14,772 10 YR PROJECTED AADT + SITE ADT W OF SITE (175) = 14,779 PEAK HOUR = 14,604 X 12.09% = 1.766= 1,083/683 DIRECTIONAL SPLIT = 61.35% / 38.65% 8.06% TRUCK % X 1,766 TRAFFIC PATTERN GROUP

SITE TRIPS GENERATED - PROPOSED

TRIP GENERATION IS BASED ON ITE TRIP GENERATION MANUAL. 10TH -DESIGN VEHICLE: SU-30.

-ONE (1) FULL SITE ACCESS PROPOSED. SITE ACCESS DESIGN VOLUMES
FRED HUDSON ROAD: 2029 AADT (HIGHEST LEG PER HIGHWAY SAFETY MANUAL PAGE 10-6) = 14,779 LEFT-TURN PEAK HOUR VOLUME

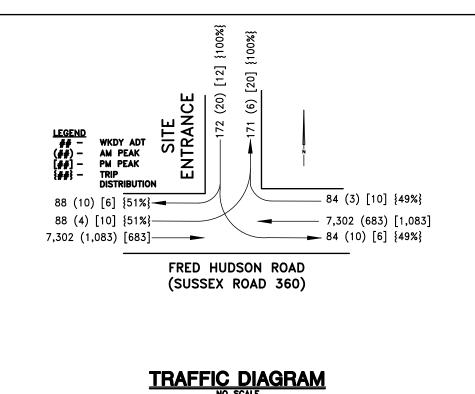

D/4994/347

S-22-28

NAVD 88

NAD 83 (DE STATE PLANE)

30 SINGLE FAMILY CONDOMINIUMS

(MR) MEDIUM DENSITY RESIDENTIAL

2259 (APPROVED BY P&Z COMMISSION ON

06/24/2021, APPROVED BY SUSSEX COUNTY COUNCIL ON

12/7/2021 AND ADOPTED THROUGH ORDINANCE NO.

2.692 AC. (INCLUDE WOODS IN R/W DEDICATION)

SUSSEX COUNTY (CEDAR NECK EXPANSION SSD)

PUBLIC (SUSSEX SHORES)

VACANT RESIDENTIAL

28' X 56' (1,568 S.F.)

4.0 UNITS/ACRE

2.6 UNITS/ACRE

42 FT. (2 STORIES)

-0.231 AC.

11.731 AC.

1.084 AC. 0.346 AC.

0.053 AC.

0.346 AC. 2.456 AC. (21%)

0.318 AC.

7.031 AC.

0.464 AC. 0.053 AC

(N:202697.0943, E:752868.2599)

(N:203172.6726, E:752941.1162)

PROPOSED BUILDING CONSTRUCTION: WOOD FRAMED/TIMBER PILE FOUNDATIONS

THE PROPERTY IS LOCATED WITHIN THE AE AND 0.2% ANNUAL CHANCE FLOOD ZONES.

THIS PROPERTY IS NOT LOCATED IN A TRANSPORTATION IMPROVEMENT DISTRICT (TID).

WETLANDS - THIS PROPERTY IS IMPACTED BY NONTIDAL WETLANDS.

THE PROPERTY IS NOT LOCATED WITHIN A WELLHEAD PROTECTION AREA.

FEMA PANEL 10005C0512K, DATED MARCH 16, 2015.

STATE STRATEGIES MAP: INVESTMENT LEVELS 2, 3, AND 4

(SCR 357) AND FRED HUDSON ROAD (SCR 360).

EVERGREENE HOMES C/O TIM NAUGHTON

701-667-7878

302-424-1441

302-424-0430

TNAUGHTON@EVERGREENEHOMES.COM

33176 COASTAL HIGHWAY, SUITE 3

DAVIS, BOWEN, & FRIEDEL, INC.

CLIFTON D. MUMFORD, P.E.

CDM@DBFINC.COM

1 PARK AVE. MILFORD, DE 19963

BETHANY BEACH, DELAWARE 19930

FRED HUDSON ROAD POSTED SPEED LIMIT: 40 M.PH.

40 FT.

10 FT.

10 FT.

15 FT.

BUILDING HEIGHT:

SIDEWALK:

BUILDINGS:

DRIVEWAYS:

TO BE REMOVED:

WOODS & WETLANDS:

LANDSCAPE BUFFER:

OTHER OPEN AREAS:

POND 2:

TOTAL L.O.D.:

SEWER PROVIDER: WATER PROVIDER:

DNREC MARKER

OWNER/DEVELOPER

EVG-COUNTY VENTURES, LLC

SCALE: 1"=800

CONCRETE MONUMENT SET:

LAT:38.5560, LON:75.0797

LAT:38.5559, LON:75.0774

SGW DISCHARGE LOCATIONS & L.O.D.:

4.82± AC.

BENCHMARK: SOUTHWEST PROPERTY CORNER


BENCHMARK: SOUTHEAST PROPERTY CORNER

WETLANDS (INCLUDED IN SITE AREA): 6.124 AC.

INLAND BAYS COMMUNITY DATA COLUMN 134-13.00-72.02

BALTIMORE HUNDRED SUSSEX COUNTY, DELAWARE

RECORD PLAN (CU #2259) FEBRUARY 2022

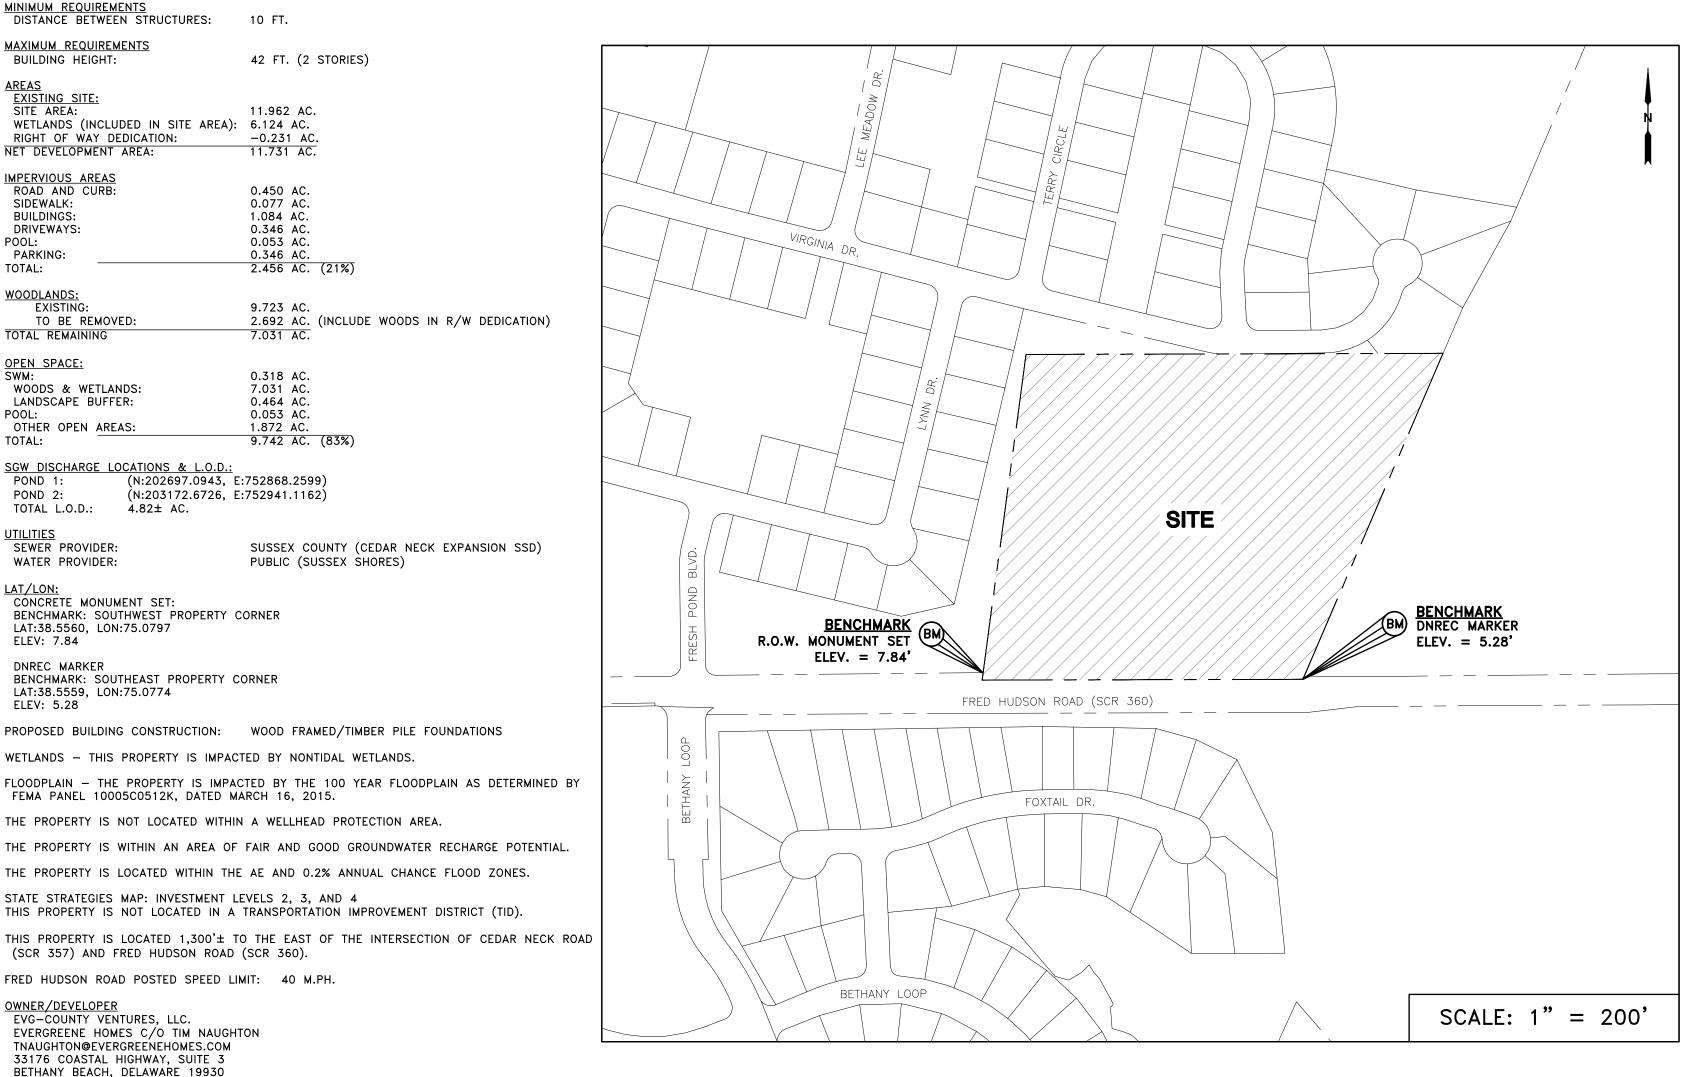

SHE	ET INDEX
TITLE SHEET	V-100
RECORD PLAN	V-101

WETLANDS STATEMENT

, EDWARD M. LAUNAY, SPWS, STATE THAT THE BOUNDARIES OF WATERS OF THE UNITED STATES INCLUDING WETLANDS SUBJECT TO THE CORPS OF ENGINEERS REGULATORY PROGRAM DELINEATED WITHIN THE AREA OF PROPOSED WORK, AS ILLUSTRATED ON THESE PLANS HAS BEEN DETERMINED USING MY PROFESSIONAL JUDGMENT IN ACCORDANCE WITH THE 1987 CORPS OF ENGINEERS WETLANDS DELINEATION MANUAL AND ALL CURRENTLY APPLICABLE SUPPLEMENTAL GUIDANCE INCLUDING THE ATLANTIC AND GULF COAST REGIONAL MANUAL (VERSION 2.0). THIS DELINEATION HAS NOT BEEN CONDUCTED FOR USDA PRÒGRAM OR AGRICULTURAL PURPOSES.

IN ACCORDANCE WITH DEPARTMENT OF NATURAL RESOURCES AND ENVIRONMENTAL CONTROL WETLAND MAPS, THERE ARE NO STATE (DNREC) REGULATED WETLANDS ON THE SITE..

EDWARD M. LAUNAY, PWS NO. 875 SOCIETY OF WETLANDS SCIENTISTS CORPS OF ENGINEERS, CERTIFIED WETLAND DELINEATOR WDCP93MD0510036B

DELDOT RECORD PLAN GENERAL NOTES

1. ALL ENTRANCES SHALL CONFORM TO THE DELAWARE DEPARTMENT OF TRANSPORTATION'S (DELDOT'S) CURRENT DEVELOPMENT COORDINATION MANUAL (DCM) AND

2. NO LANDSCAPING SHALL BE ALLOWED WITHIN R/W UNLESS THE PLANS ARE COMPLIANT WITH SECTION 3.7 OF THE DEVELOPMENT COORDINATION MANUAL (DCM).

3. SHRUBBERY, PLANTINGS, SIGNS AND/OR OTHER VISUAL BARRIERS THAT COULD OBSTRUCT THE SIGHT DISTANCE OF A DRIVER PREPARING TO ENTER THE ROADWAY ARE PROHIBITED WITHIN THE DEFINED DEPARTURE SIGHT TRIANGLE AREA ESTABLISHED ON THIS PLAN. IF THE ESTABLISHED DEPARTURE SIGHT TRIANGLE AREA IS OUTSIDE THE RIGHT-OF-WAY OR PROJECTS ONTO AN ADJACENT PROPERTY OWNER'S LAND, A SIGHT EASEMENT SHOULD BE ESTABLISHED AND RECORDED WITH ALL AFFECTED PROPERTY OWNERS TO MAINTAIN THE REQUIRED SIGHT DISTANCE.

4. UPON COMPLETION OF THE CONSTRUCTION OF THE SHARED-USE PATH ACROSS THIS PROJECT'S FRONTAGE AND PHYSICAL CONNECTION TO ADJACENT EXISTING FACILITIES, THE DEVELOPER, THE PROPERTY OWNERS OR BOTH ASSOCIATED WITH THIS PROJECT, SHALL BE RESPONSIBLE TO REMOVE ANY EXISTING ROAD TIE-IN CONNECTIONS LOCATED ALONG ADJACENT PROPERTIES, AND RESTORE THE AREA TO GRASS. SUCH ACTIONS SHALL BE COMPLETED AT DELDOT'S DISCRETION, AND IN CONFORMANCE WITH DELDOT'S DEVELOPMENT COORDINATION MANUAL.

5. PRIVATE STREETS CONSTRUCTED WITHIN THIS DEVELOPMENT SHALL BE MAINTAINED BY THE DEVELOPER, THE PROPERTY OWNERS WITHIN THIS SUBDIVISION OR BOTH (TITLE 17 §131). DELDOT ASSUMES NO RESPONSIBILITIES FOR THE FUTURE MAINTENANCE OF THESE STREETS.

6. THE SIDEWALK AND SHARED-USE PATH SHALL BE THE RESPONSIBILITY OF THE DEVELOPER, THE PROPERTY OWNERS OR BOTH WITHIN THIS DEVELOPMENT. THE STATE OF DELAWARE ASSUMES NO RESPONSIBILITY FOR THE FUTURE MAINTENANCE OF THE SIDEWALK AND/OR SHARED-USE PATH.

7. ALL UNITS SHALL HAVE ACCESS FROM THE INTERNAL PRIVATE STREET.

8. TO MINIMIZE RUTTING AND EROSION OF THE ROADSIDE DUE TO ON-STREET PARKING, DRIVEWAY AND BUILDING LAYOUTS MUST BE CONFIGURED TO ALLOW FOR VEHICLES TO BE STORED IN THE DRIVEWAY BEYOND THE RIGHT-OF-WAY, WITHOUT INTERFERING WITH SIDEWALK ACCESS AND CLEARANCE.

9. THE DEVELOPER SHALL BE REQUIRED TO FURNISH AND PLACE RIGHT-OF-WAY MONUMENTS IN ACCORDANCE WITH DELDOT'S DEVELOPMENT COORDINATION MANUAL.

10. THE DEVELOPER SHALL BE REQUIRED TO FURNISH AND PLACE RIGHT-OF-WAY MARKERS TO PROVIDE A PERMANENT REFERENCE FOR RE-ESTABLISHING THE RIGHT-OF-WAY AND PROPERTY CORNERS ON LOCAL AND HIGHER ORDER FRONTAGE ROADS. RIGHT-OF-WAY MARKERS SHALL BE SET AND/OR PLACED ALONG THE FRONTAGE ROAD RIGHT-OF-WAY AT PROPERTY CORNERS AND AT EACH CHANGE IN RIGHT-OF-WAY ALIGNMENT IN ACCORDANCE WITH SECTION 3.2.4.2 OF THE DEVELOPMENT COORDINATION MANUAL.

CONDITIONS OF APPROVAL (CU 2259):

AT THEIR MEETING OF TUESDAY, DECEMBER 7, 2021, THE SUSSEX COUNTY COUNCIL APPROVED THE CONDITIONAL USE APPLICATION FOR MULTIFAMILY DWELLING UNITS (30) SUBJECT TO NINETEEN (19) CONDITIONS. THE CONDITIONAL USE SHALL BE SUBSTANTIALLY UNDERWAY WITHIN THREE (3) YEARS OF THE COUNTY COUNCIL APPROVAL OTHERWISE THE CONDITIONAL USE SHALL EXPIRE. A SITE PLAN SHOWING THE CONDITIONS OF APPROVAL SHALL BE REVIEWED AND APPROVED BY THE PLANNING COMMISSION PRIOR TO COMMENCEMENT OF THE USE ON THE PARCEL. THE FOLLOWING ARE THE CONDITIONS:

A. THE MAXIMUM NUMBER OF RESIDENTIAL UNITS WITHIN THIS ENTIRE DEVELOPMENT SHALL BE 30.

B. THE APPLICANT SHALL FORM A CONDOMINIUM ASSOCIATION TO BE RESPONSIBLE FOR THE PERPETUAL MAINTENANCE OF THE DEVELOPMENT'S ROADWAYS, BUFFERS, STORMWATER MANAGEMENT FACILITIES, EROSION AND SEDIMENTATION CONTROL FACILITIES AND OTHER COMMON AREAS.

C. ALL ENTRANCE, INTERSECTION, ROADWAY AND MULTI-MODAL IMPROVEMENTS SHALL BE COMPLETED BY THE DEVELOPER IN ACCORDANCE WITH ALL DELDOT

D. THE PROJECT SHALL BE SERVED BY SUSSEX COUNTY SEWER. THE DEVELOPER SHALL COMPLY WITH ALL SUSSEX COUNTY ENGINEERING DEPARTMENT REQUIREMENTS INCLUDING ANY OFFSITE UPGRADES NECESSARY TO PROVIDE SERVICE TO THE PROJECT

E. THE PROJECT SHALL BE SERVED BY CENTRAL WATER TO PROVIDE DRINKING WATER AND FIRE PROTECTION

F. STREET NAMING AND ADDRESSING SHALL BE SUBJECT TO THE REVIEW AND APPROVAL OF THE SUSSEX COUNTY MAPPING AND ADDRESSING DEPARTMENT.

G. THE FINAL SITE PLAN SHALL CONTAIN THE APPROVAL OF THE SUSSEX COUNTY CONSERVATION DISTRICT FOR THE DESIGN AND LOCATION OF ALL STORMWATER MANAGEMENT AREAS AND EROSION AND SEDIMENTATION CONTROL FACILITIES.

H. ALL STREETLIGHTS SHALL BE SHIELDED AND DOWNWARD SCREENED SO THAT THEY DO NOT SHINE ON NEIGHBORING PROPERTIES OR ROADWAYS.

THE INTERIOR STREET DESIGN SHALL MEET OR EXCEED SUSSEX COUNTY'S STREET DESIGN REQUIREMENTS. THERE SHALL BE SIDEWALKS ON AT LEAST ONE SIDE

J. IF REQUESTED BY THE LOCAL SCHOOL DISTRICT, A SCHOOL BUS STOP SHALL BE PROVIDED. THE LOCATION OF THE BUS STOP SHALL BE SHOWN ON THE FINAL

K. RECREATIONAL AMENITIES SHALL BE COMPLETED NO LATER THAN THE ISSUANCE OF THE 15TH RESIDENTIAL BUILDING PERMIT. THESE AMENITIES SHALL INCLUDE

CONSTRUCTION SITE WORK AND DELIVERIES SHALL ONLY OCCUR ON THE SITE BETWEEN THE HOURS OF 7:00AM THROUGH 6:00PM, MONDAY THROUGH FRIDAY. NO SATURDAY OR SUNDAY HOURS ARE PERMITTED. A 24 INCH BY 36 INCH "NOTICE" SIGN CONFIRMING THESE HOURS SHALL BE PROMINENTLY DISPLAYED AT ALL ENTRANCES TO THE SITE DURING CONSTRUCTION.

M. ALL OF THE BUILDINGS SHALL BE SET BACK AT LEAST 20 FEET FROM ALL NON-TIDAL WETLANDS.

THERE SHALL BE A VEGETATED OR FORESTED BUFFER THAT IS AT LEAST 20 FEET WIDE INSTALLED ALONG THE WESTERN PERIMETER OF THIS DEVELOPMENT THIS SHALL UTILIZE THE EXISTING POPLAR TREES WITHIN THE BUFFER AREA WITH VEGETATION ADDED AS A SCREEN IN ACCORDANCE WITH THE REQUIREMENTS OF SECTIONS 115-218D AND 99-5 OF THE COUNTY CODE. WHERE THE TREES CURRENTLY EXIST IN THE BUFFER AREA, STUMP REMOVAL OR CONSTRUCTION ACTIVITIES THAT DISTURB THE EXISTING GRADE OF THE AREA WITHIN THE BUFFER SHALL BE PROHIBITED. ALL SILT FENCING SHALL BE LOCATED ALONG THE INTERIOR LIMIT OF THE BUFFER AREA (THE EDGE OF THE BUFFER NEAREST THE INTERIOR DEVELOPMENT) AND THE FINAL SITE PLAN SHALL IDENTIFY THE "LIMIT OF DISTURBANCE" TO PREVENT DISTURBANCE OF THE BUFFER AREA. IN ADDITION, A SPLIT RAIL OR SIMILAR TYPE OF FENCE SHALL BE INSTALLED ALONG THE BOUNDARY LINE OF THE PROPERTY NEXT TO THE BUFFER. THE BUFFER SHALL CONTINUE ALONG THE NORTH BOUNDARY FROM THE SITE'S NORTHWEST CORNER TO A POINT WHERE THE COUNTY SEWER EASEMENT BEGINS. FROM THAT POINT TO THE POINT OF THE EXISTING COUNTY SEWER TIE-IN, THE APPLICANT SHALL CONSTRUCT A PRIVACY FENCE AT LEAST SIX (6) FEET IN HEIGHT ALONG THE NORTHERN BOUNDARY.

O. THE FINAL SITE PLAN SHALL INCLUDE A LANDSCAPE PLAN CONFIRMING ALL LANDSCAPING TO BE PROVIDED. THE PRESERVATION OF ALL BUFFER AREAS AND THE FORESTED AREAS THAT WILL BE PRESERVED. THIS LANDSCAPE PLAN SHALL FURTHER IDENTIFY ALL "LIMITS OF DISTURBANCE" WITHIN THE SITE.

P. THE FINAL SITE PLAN SHALL INCLUDE A GRADING PLAN FOR THE SITE. NO BUILDING PERMITS SHALL BE ISSUED UNTIL A LOT GRADING PLAN HAS BEEN SUPPLIED TO AND APPROVED BY SUSSEX COUNTY. NO CERTIFICATE OF OCCUPANCY SHALL BE ISSUED UNTIL A GRADING CERTIFICATE IS SUBMITTED TO THE BUILDING CODE DEPARTMENT DEMONSTRATING GENERAL CONFORMITY WITH THE INDIVIDUAL SITE GRADING PLAN.

Q. AS PROFFERED BY THE APPLICANT, THE FINAL SITE PLAN AND THE RECORDED CONDOMINIUM COVENANTS SHALL PROHIBIT THE APPLICATION OF FERTILIZERS OR SIMILAR SOIL ADDITIVES ON THE PROPERTY BY THE INDIVIDUAL UNIT OWNERS. ALL SUCH APPLICATIONS SHALL BE MANAGED BY THE CONDOMINIUM ASSOCIATION AND A CONTRACTOR OF ITS DESIGNATION USING BEST MANAGEMENT PRACTICES TO SEEK TO MINIMIZE THE RISK OF RUNOFF INTO THE STORMWATER MANAGEMENT SYSTEM. WETLANDS AND WATERWAYS

R. FAILURE TO ABIDE BY THESE CONDITIONS MAY BE GROUNDS FOR THE TERMINATION OF THIS CONDITIONAL USE.

S. THE FINAL SITE PLAN SHALL BE SUBJECT TO THE REVIEW AND APPROVAL OF THE SUSSEX COUNTY PLANNING AND ZONING COMMISSION.

GENERAL NOTES

1. ALL FIRE LANES, FIRE HYDRANTS, AND FIRE DEPARTMENT CONNECTIONS SHALL BE MARKED IN ACCORDANCE WITH THE DELAWARE STATE FIRE PREVENTION REGULATIONS. BUILDING CONSTRUCTION TO BE WOOD FRAMED AND TIMBER PILE FOUNDATIONS.

AREA, SHALL BE OWNED AND MAINTAINED BY THE COMMUNITY'S HOMEOWNER'S ASSOCIATION. THE DEVELOPER SHALL MAINTAIN THESE AREAS UNTIL THE COMMUNITY HOMEOWNER'S ASSOCIATION IS ESTABLISHED.

2. AFTER THE CREATION OF THE COMMUNITY'S HOMEOWNER'S ASSOCIATION ALL BUFFER AREAS, AND THE STORMWATER MANAGEMENT

3. BOUNDARY AND TOPOGRAPHICAL INFORMATION SHOWN ON THIS PLAN ARE THE RESULT OF A FIELD RUN SURVEY PERFORMED BY DAVIS, BOWEN AND FRIEDEL, INC. (DBF) IN SEPTEMBER 2015. ADDITIONAL SURVEY WAS COMPLETED IN MAY 2020.

4. THIS PLAN DOES NOT VERIFY THE LOCATION, EXISTENCE, OR NON-EXISTENCE OF EASEMENTS OR RIGHT-OF-WAYS CROSSING THE SUBJECT PROPERTY AS NO TITLE SEARCH WAS PERFORMED OR PROVIDED.

5. THIS PROPERTY IS NOT LOCATED WITHIN A WELLHEAD PROTECTION AREA OR AN EXCELLENT RECHARGE AREA.

6. ANY PROPOSED SIGNAGE WILL REQUIRE A SEPARATE PERMIT ISSUED FROM THE COUNTY,

ENGINEER'S STATEMENT

, CLIFTON D. MUMFORD, P.E., HEREBY STATE THAT I AM A REGISTERED ENGINEER IN THE STATE OF DELAWARE. THAT THE INFORMATION SHOWN HEREON HAS BEEN PREPARED UNDER MY SUPERVISION AND TO MY BEST KNOWLEDGE AND BELIEF REPRESENTS GOOD ENGINEERING PRACTICES AS REQUIRED BY THE APPLICABLE LAWS OF THE STATE OF DELAWARE.

OWNER'S CERTIFICATION


I, THE UNDERSIGNED, HEREBY CERTIFY THAT I AM THE OWNER OF THE PROPERTY DESCRIBED ON THIS PLAN, THAT THE PLAN WAS MADE BY MY DIRECTION AND THAT I ACKNOWLEDGE THE SAME TO BE MY ACT AND DESIRE THE PLAN TO BE RECORDED AS SHOWN IN ACCORDANCE WITH ALL APPLICABLE LAWS AND REGULATIONS.


DATE


EVG-COUNTY VENTURES, LLC EVERGREENE HOMES C/O TIM NAUGHTON 33716 COASTAL HIGHWAY, SUITE 3 BETHANY BEACH, DE 19930

DAVIS, BOWEN & FRIEDEL, INC

by CLIFTON D. MUMFORD, P.E.

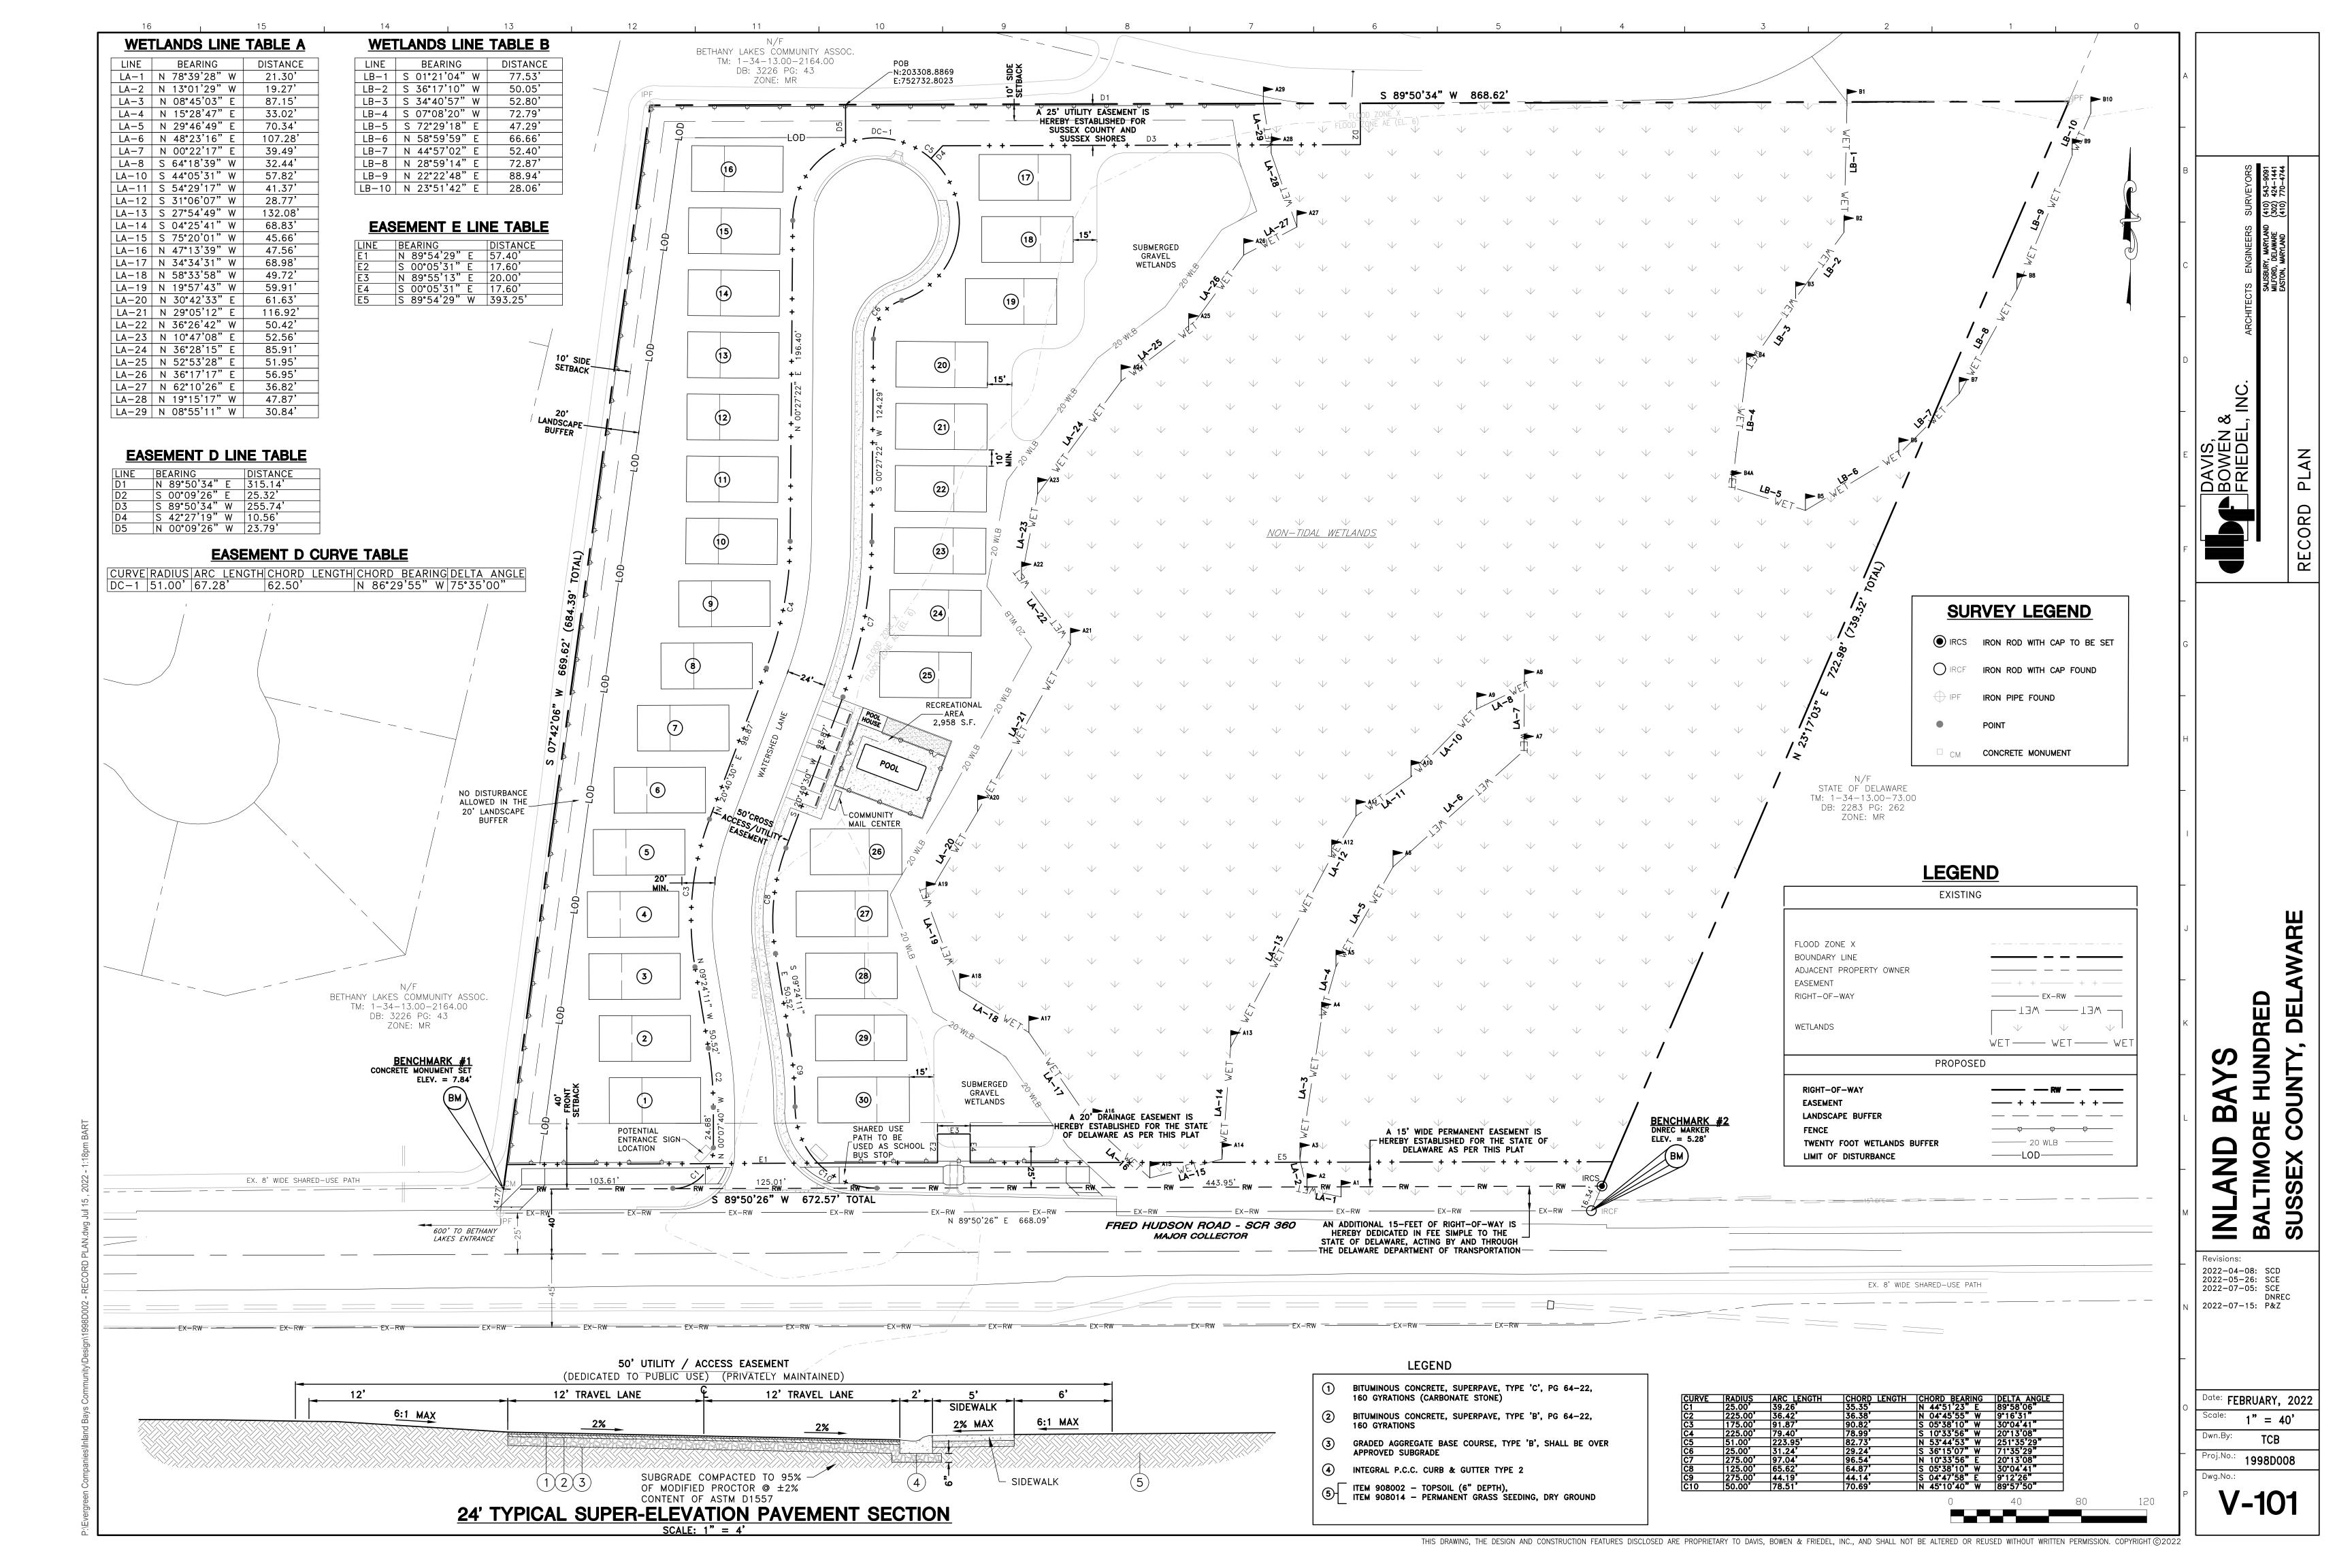

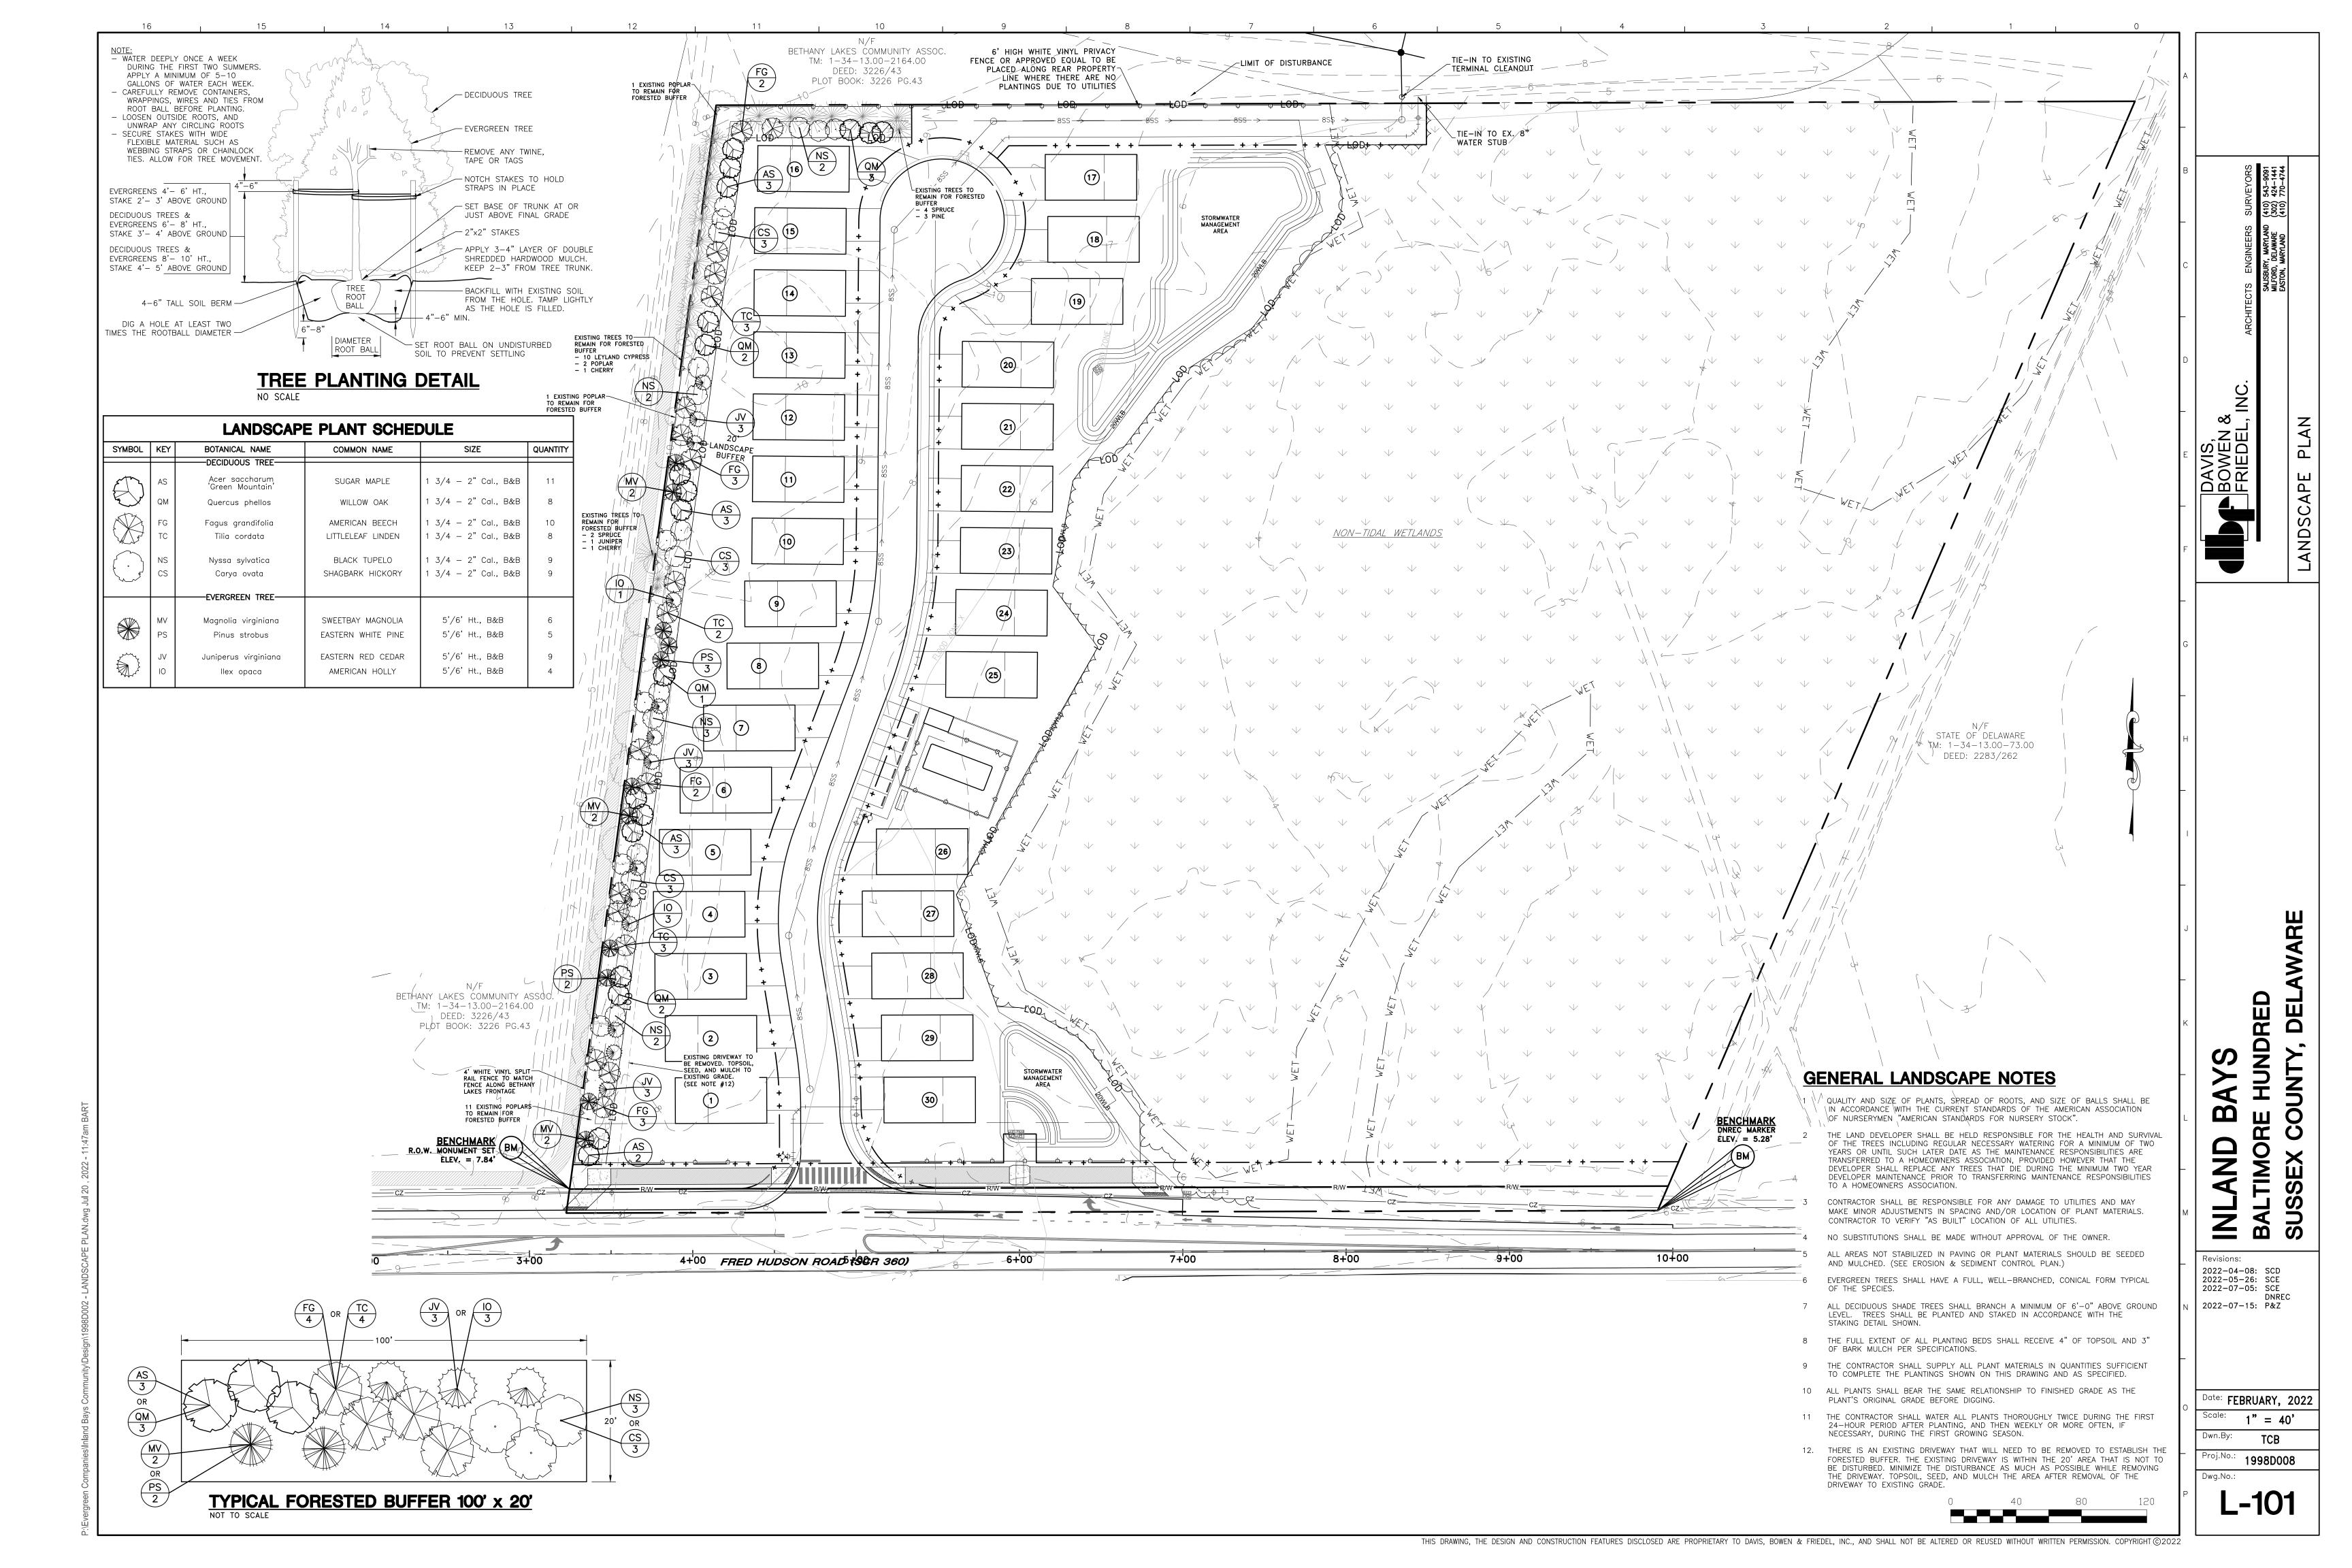

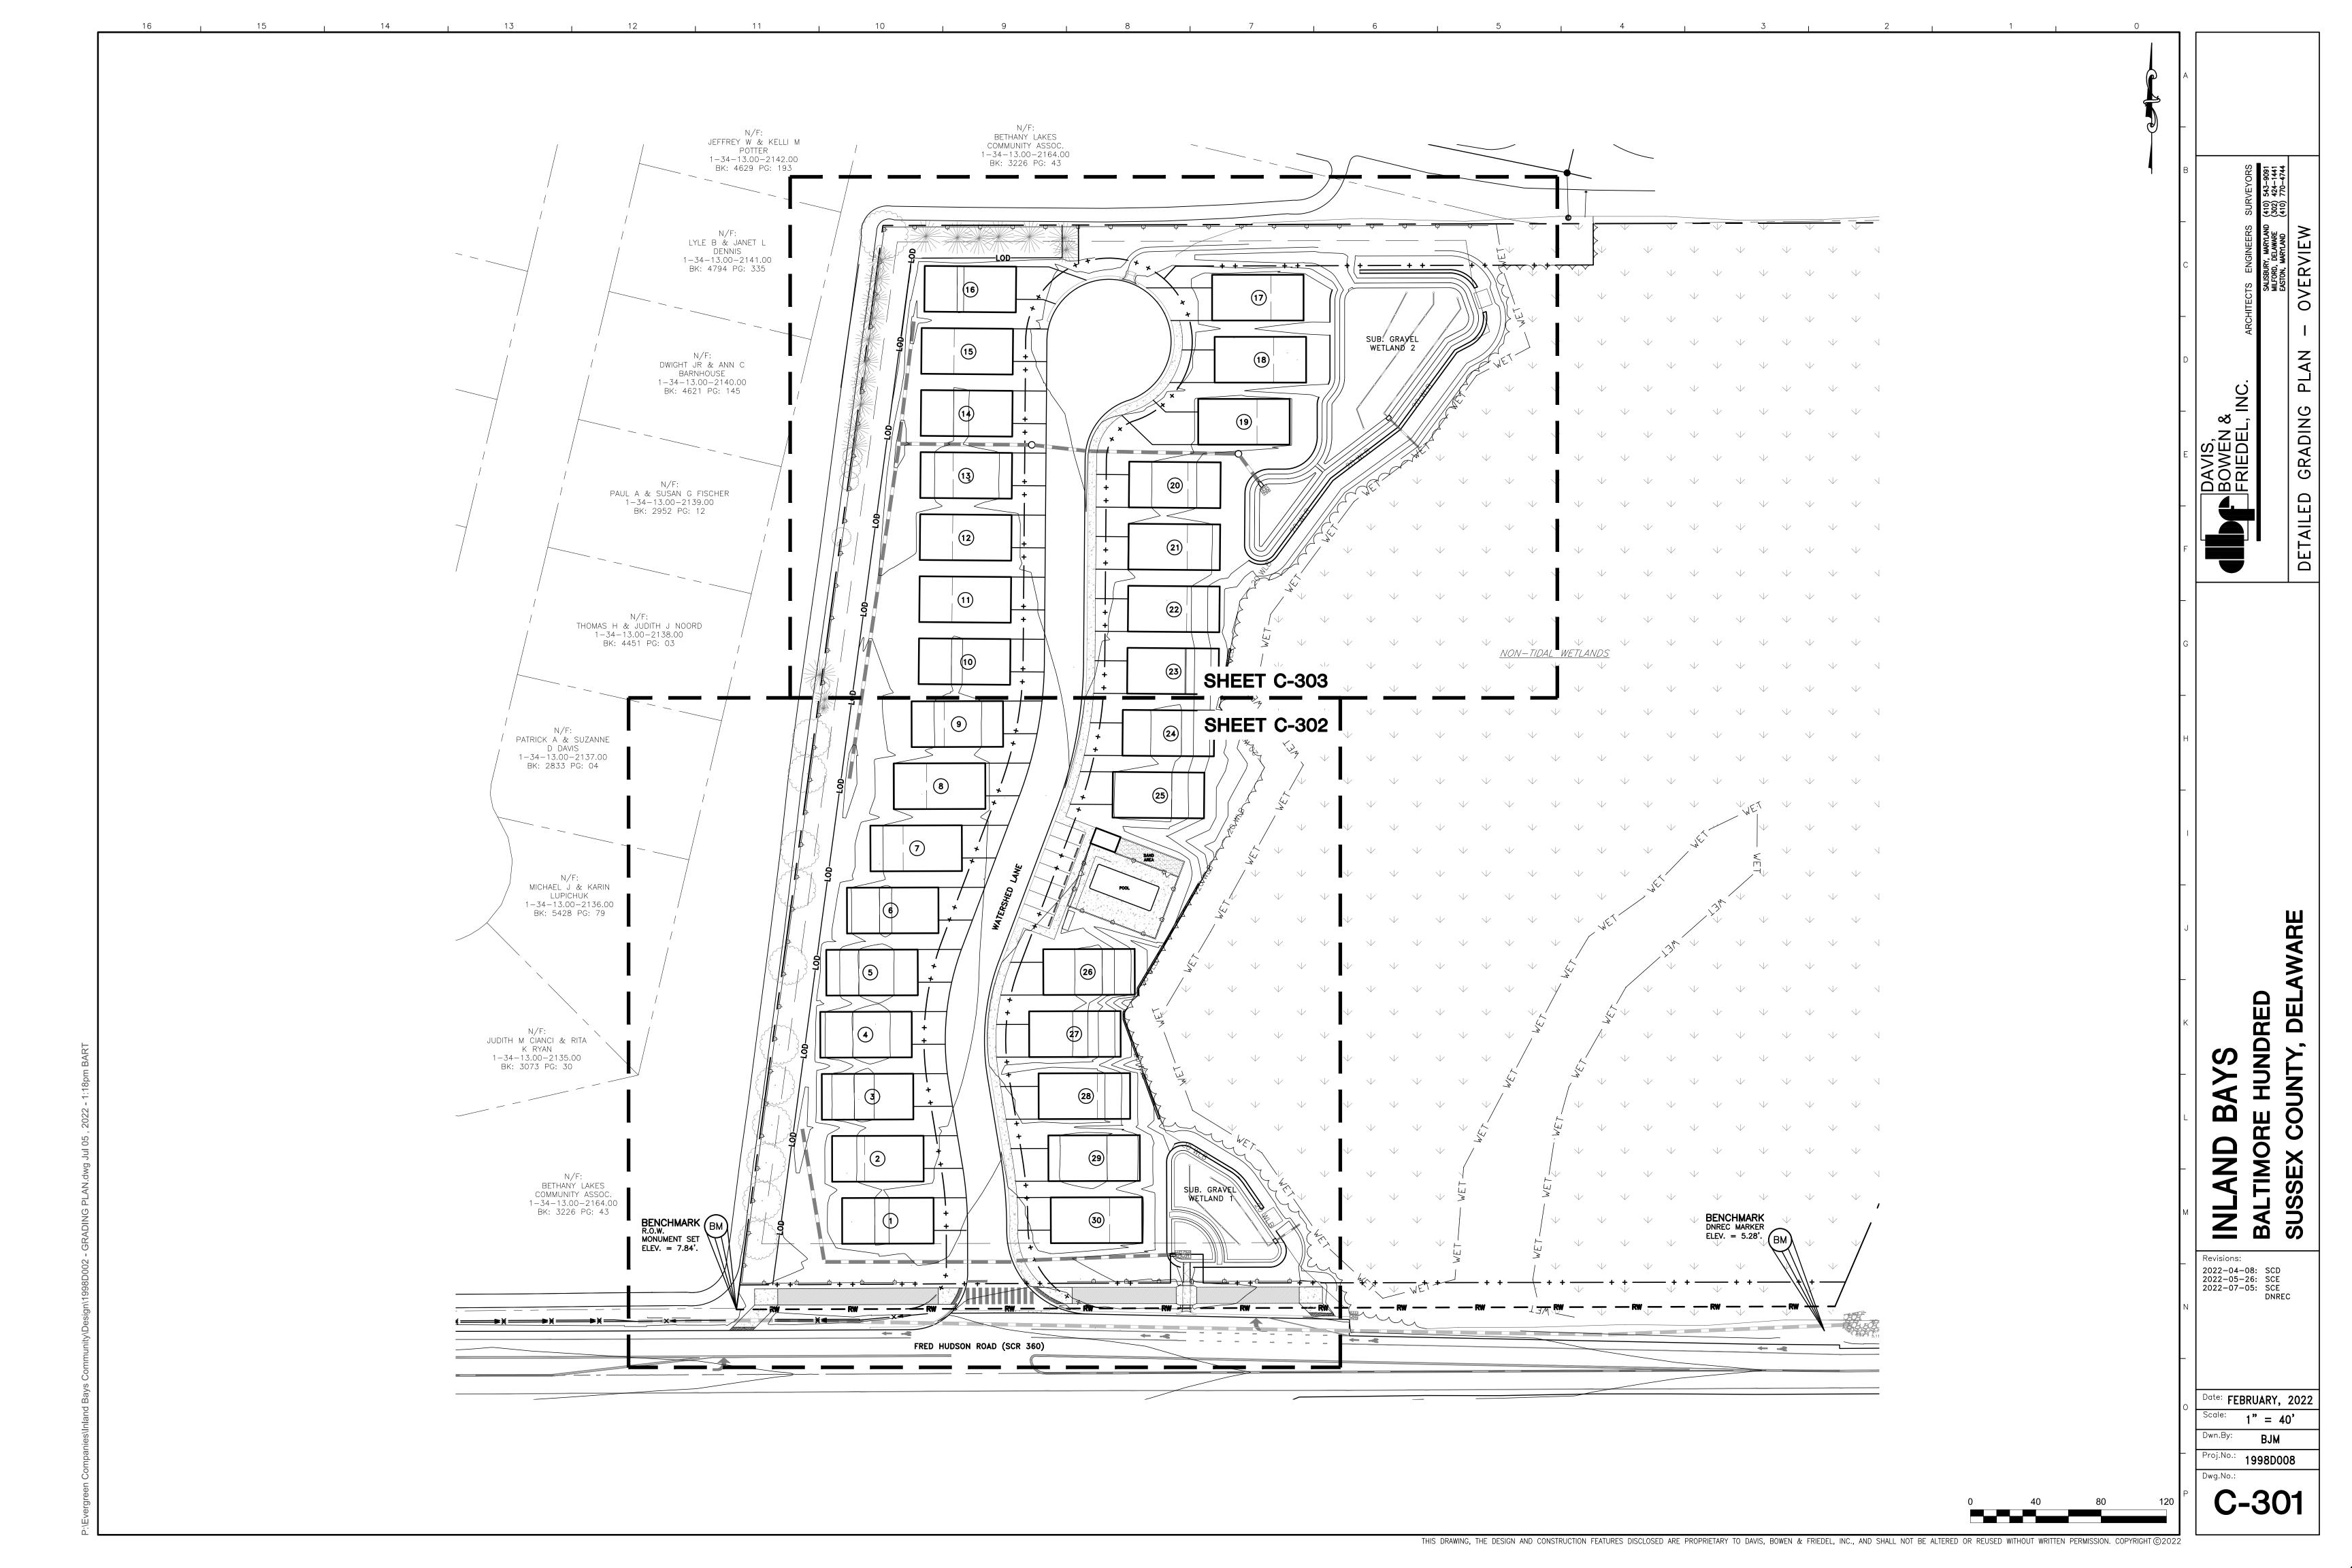




DAVIS, BOWEN FRIEDEL


DEL HUNDRED

BAL 2022-04-08: SCD 2022-05-26: SCE 2022-07-05: SCE DNREC

Date: FEBRUARY, 2022 Scale: 1" = 20' Dwn.By: BJM

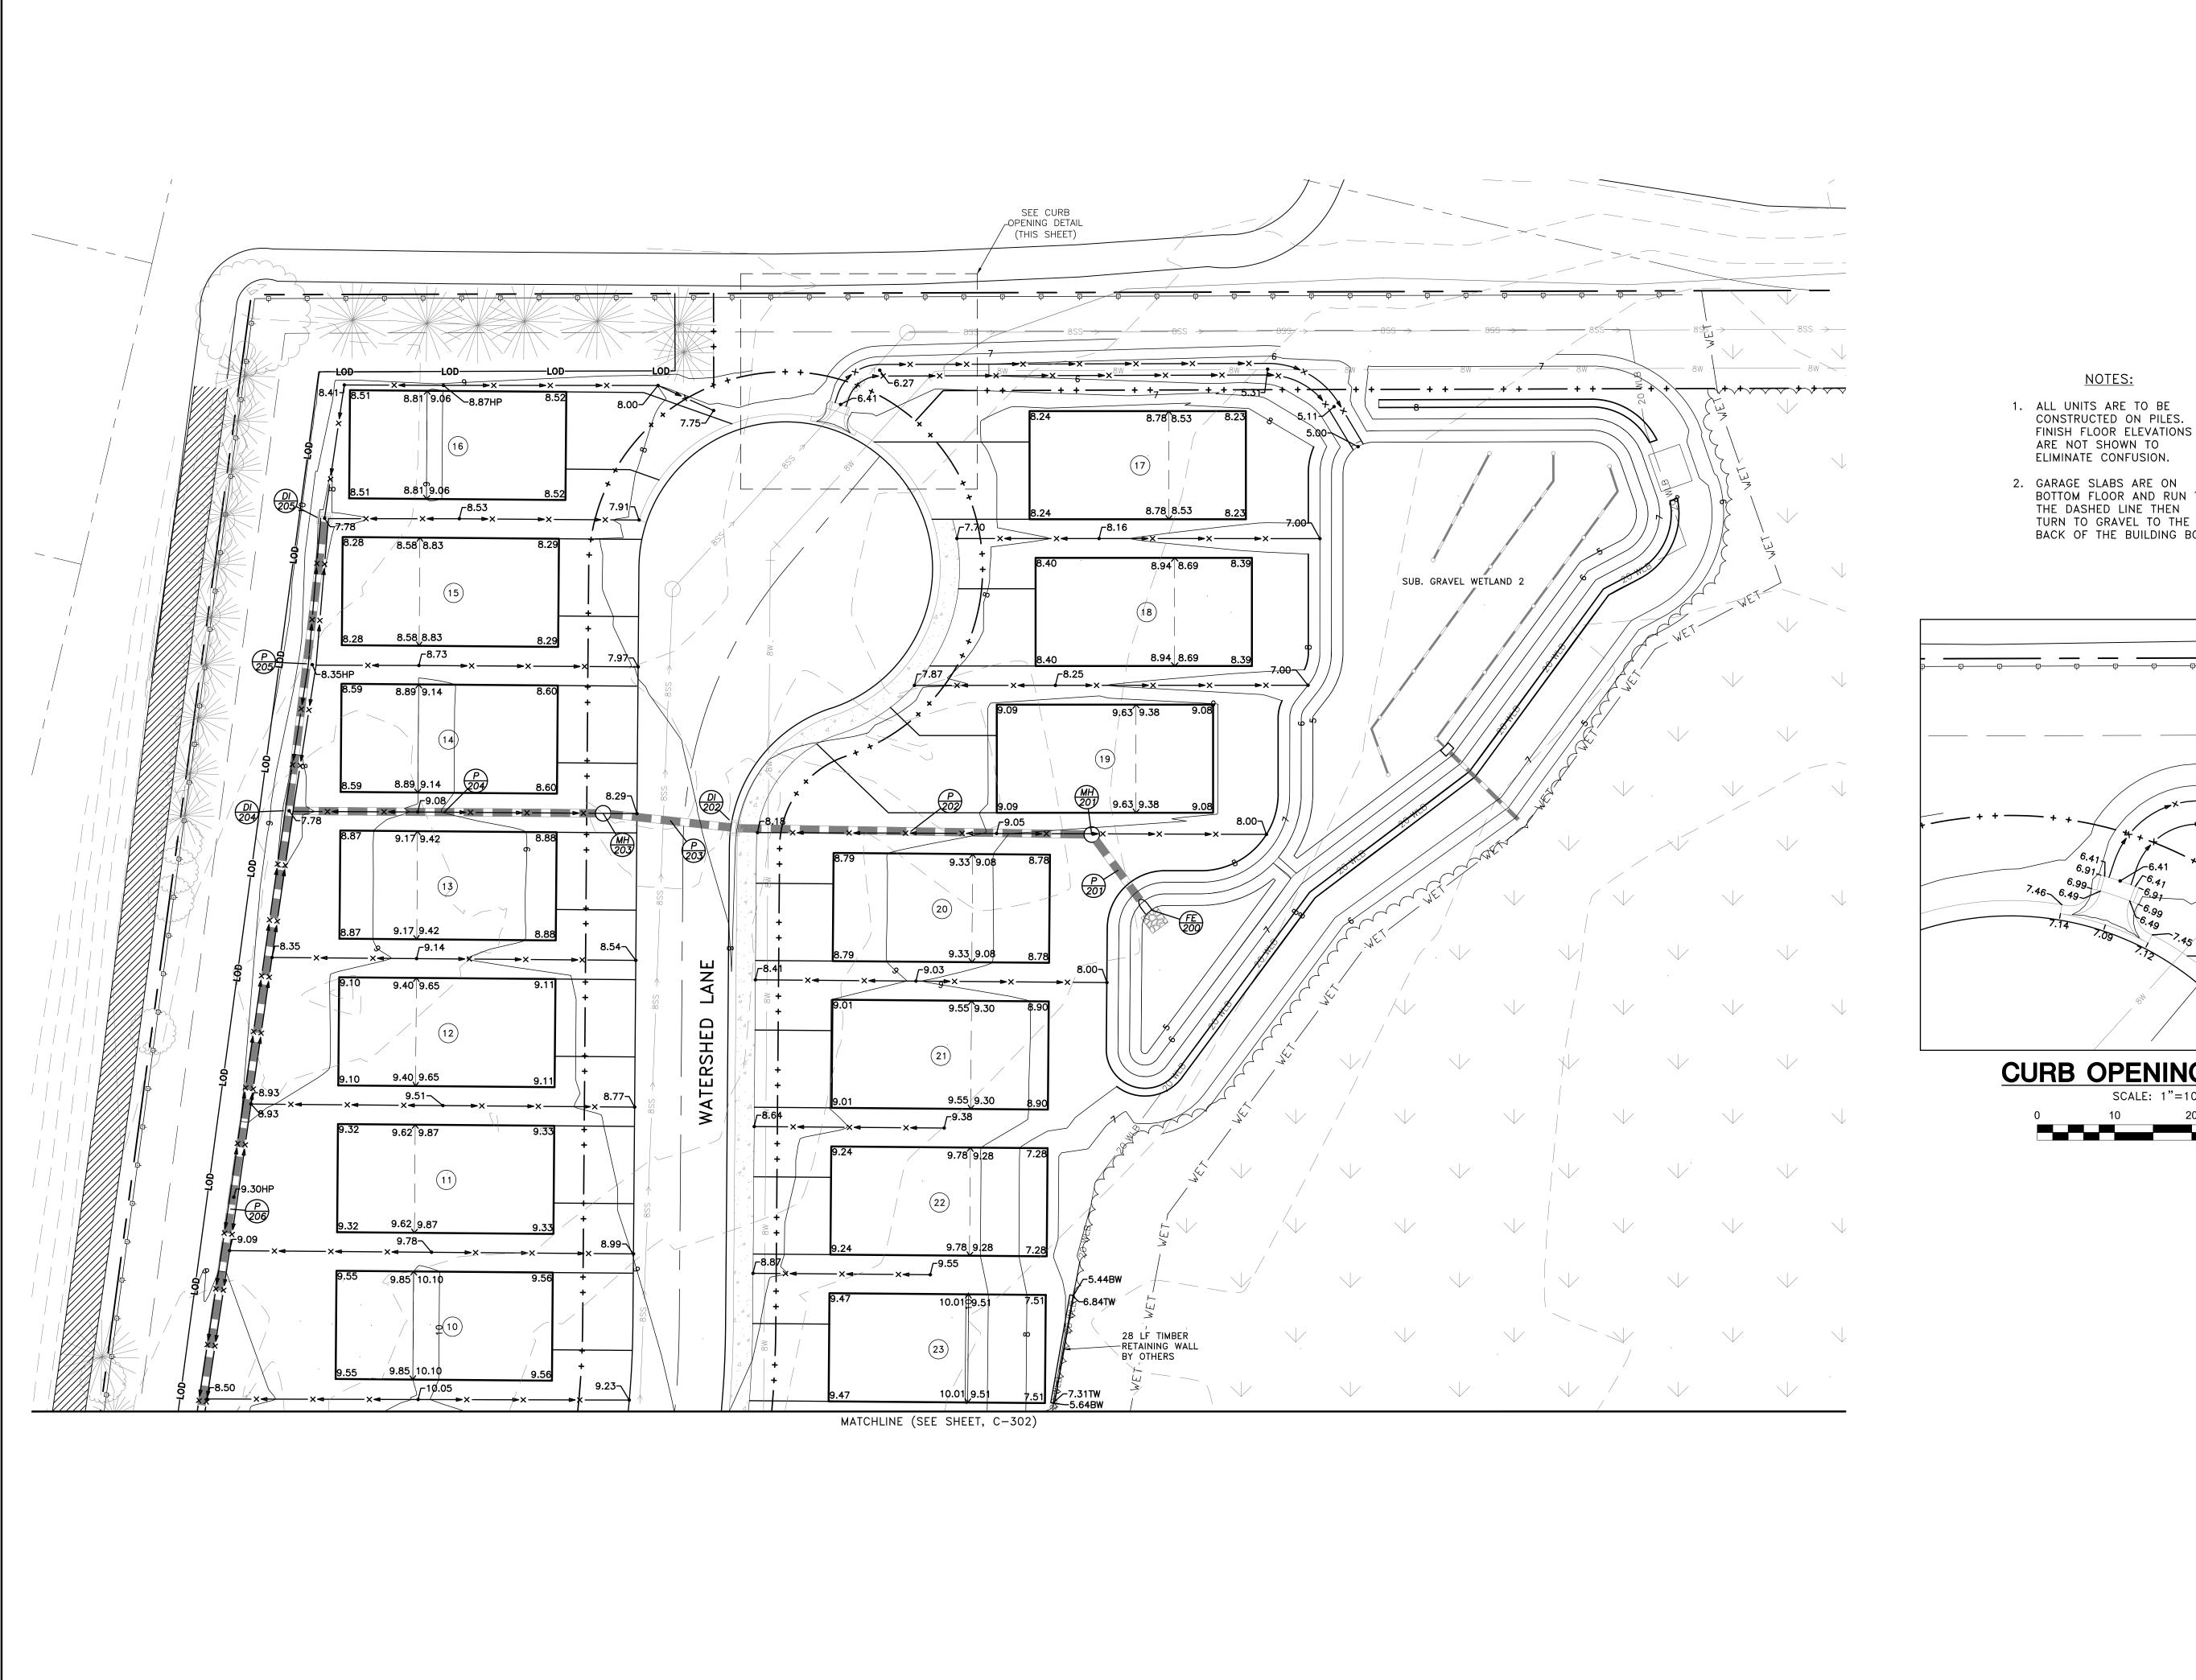

 GARAGE SLABS ARE ON BOTTOM FLOOR AND RUN TO THE DASHED LINE THEN TURN TO GRAVEL TO THE BACK OF THE BUILDING BOX.

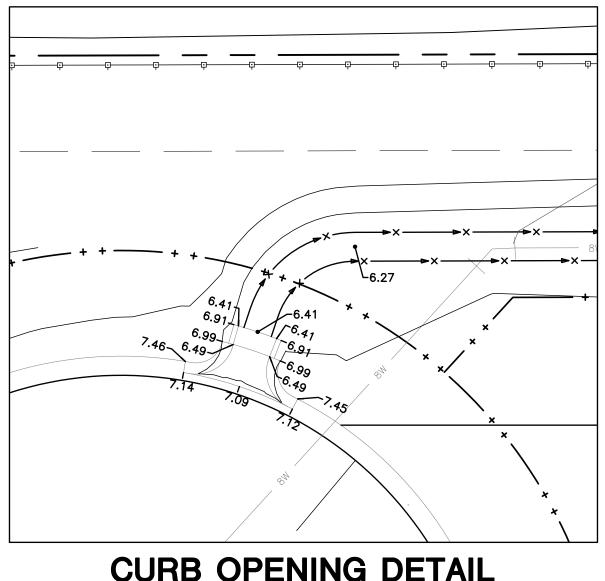

CURB OPENING DETAIL

THIS DRAWING, THE DESIGN AND CONSTRUCTION FEATURES DISCLOSED ARE PROPRIETARY TO DAVIS, BOWEN & FRIEDEL, INC., AND SHALL NOT BE ALTERED OR REUSED WITHOUT WRITTEN PERMISSION. COPYRIGHT ©2022


DEL HUNDRED COUNTY, **BALTIMORE**

DAVIS, BOWEN FRIEDEL

2022-04-08: SCD 2022-05-26: SCE 2022-07-05: SCE DNREC

Date: FEBRUARY, 2022 Scale: 1" = 20'

Dwn.By: BJM Proj.No.: **1998D008**

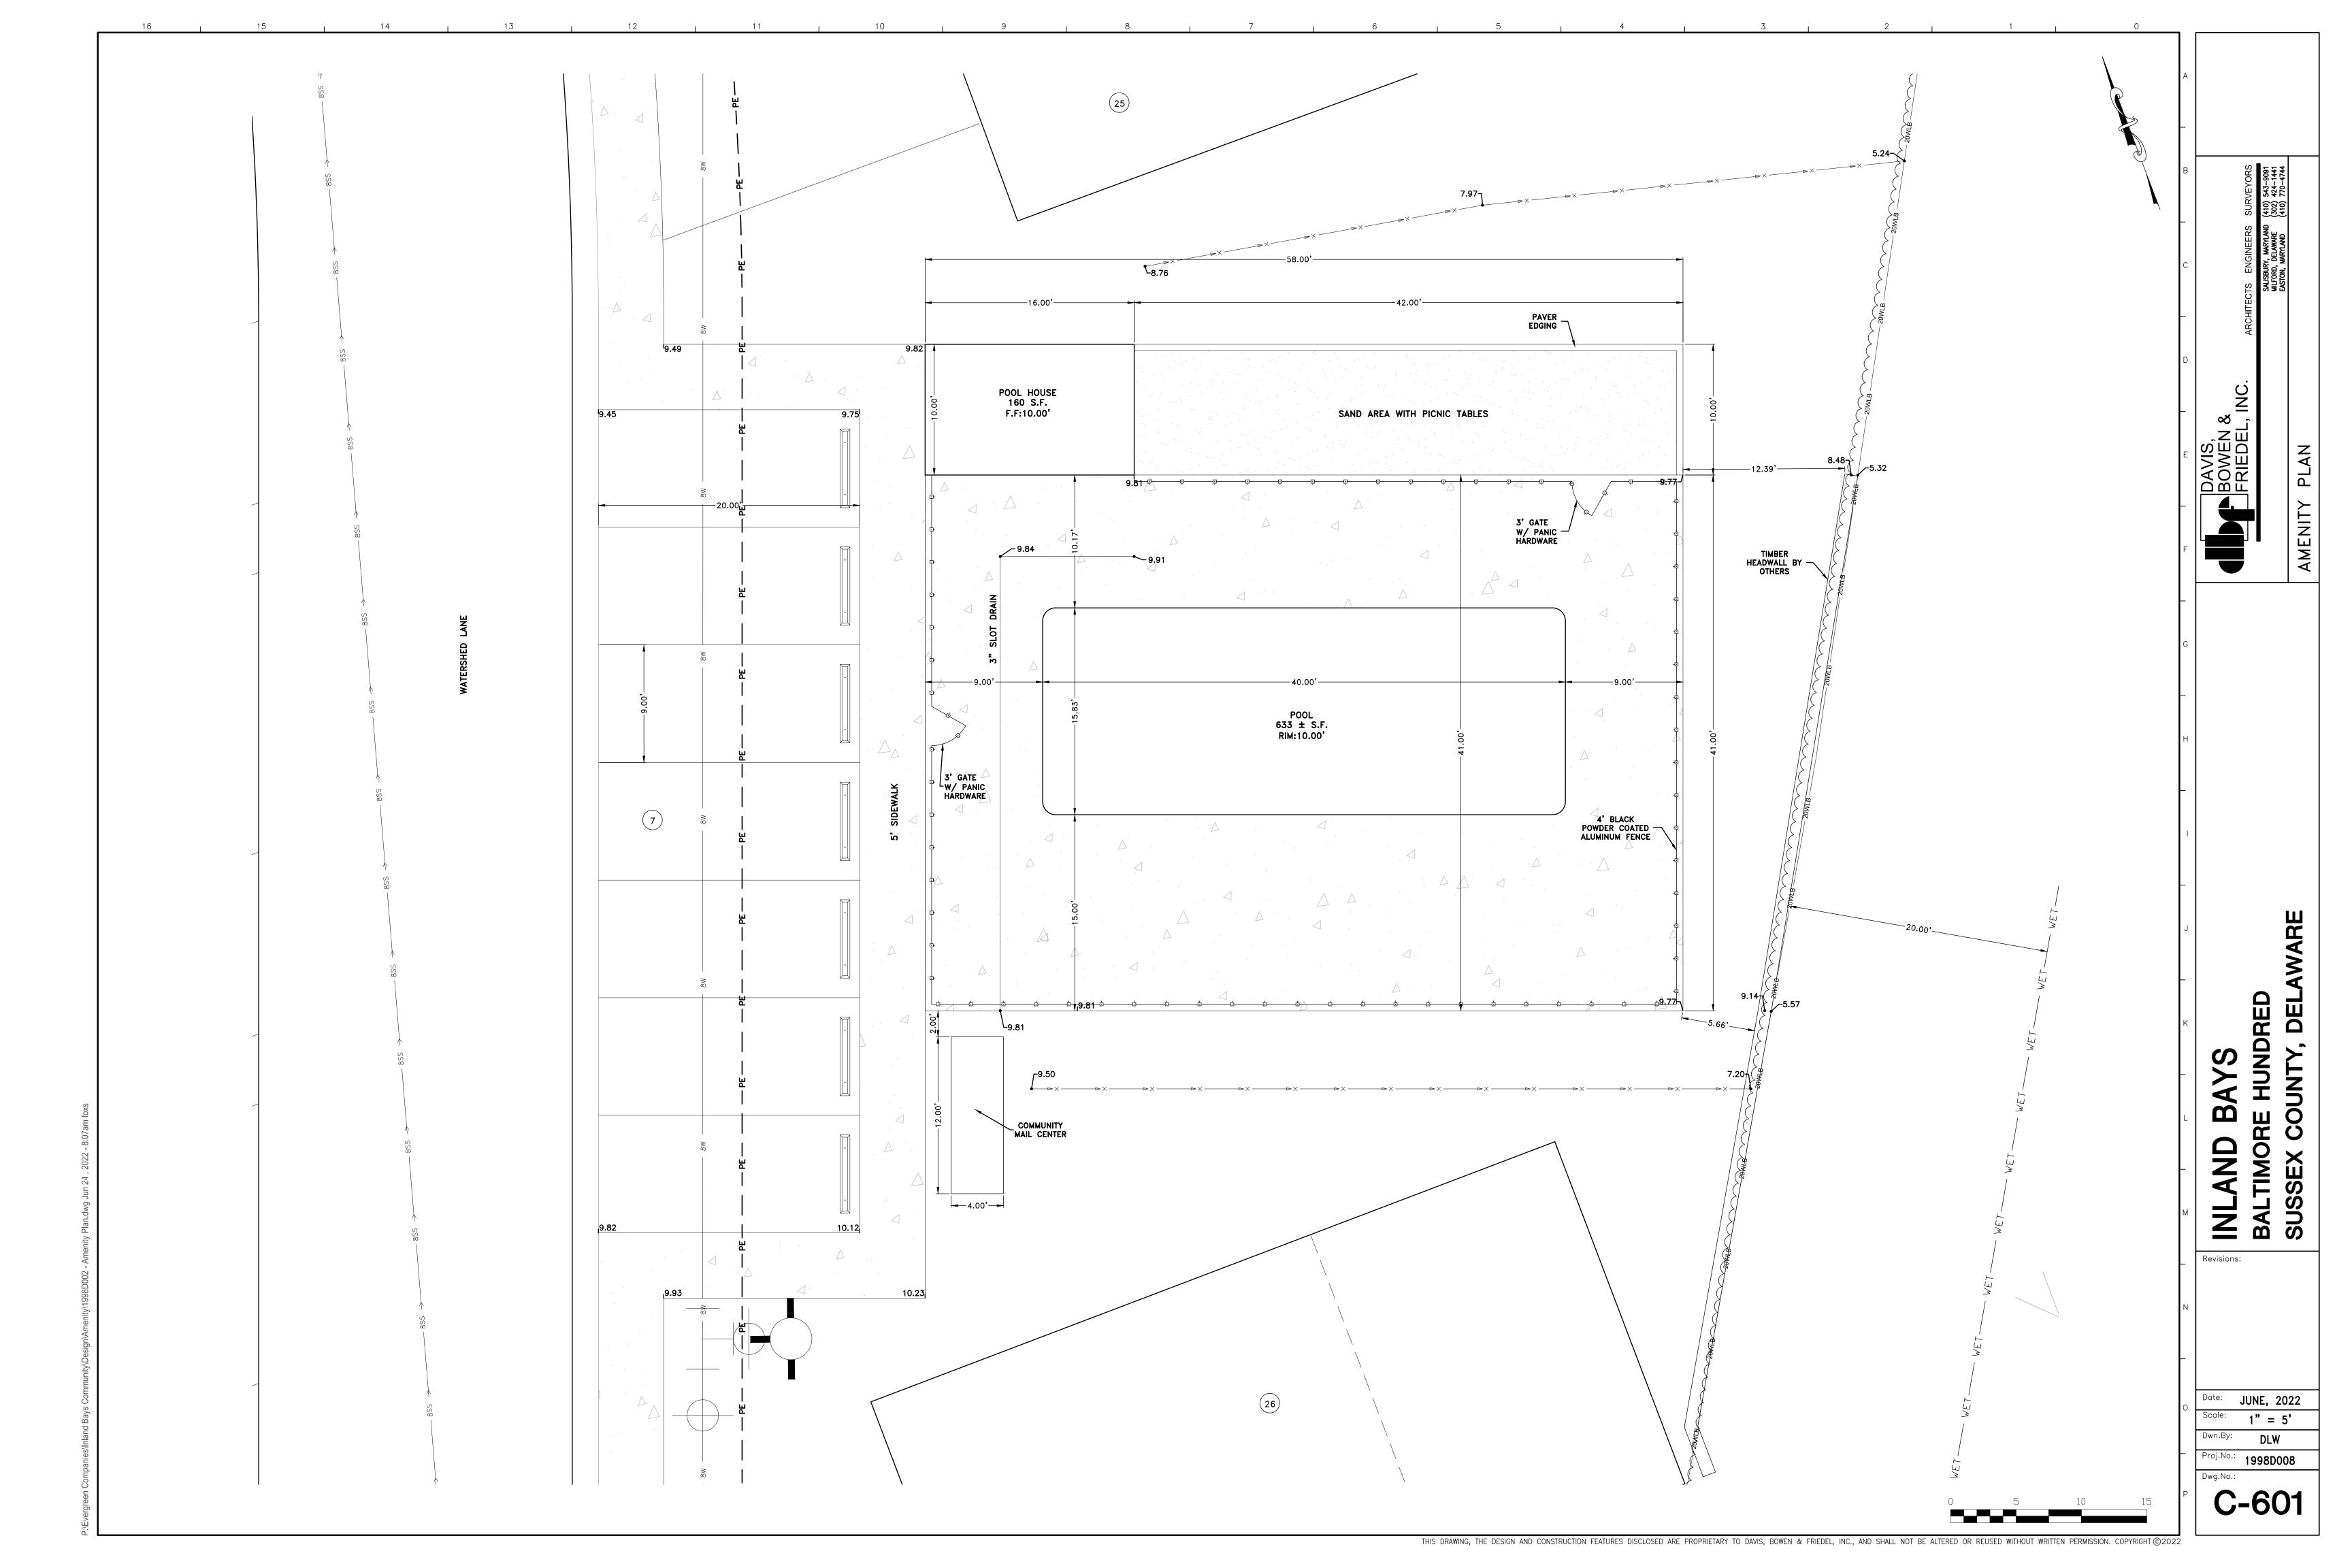

INDIAN RIVER SOLAR FARM (FORMERLY KNOWN AS BROOM SOLAR)

ADJACENT TO 32419 FRANKFORD SCHOOL ROAD, FRANKFORD, DELAWARE, 19945

PRELIMINARY SITE PLAN SET

PROJECT CONTACT LIST

DEVELOPER/CONTRACTO

CIVIL ENGINEER
TRC ENGINEERS, INC.
1430 BROADWAY, 10TH FLOOR
NEW YORK, NY 10018
CONTACT: STEVEN MEERSMA, PE
PHONE: 212.221.7840
EMAIL: SMEERSMA@TRCCOMPANIES.CON

ELECTRICAL ENGINEER

PREPARED FOR: BROOM SOLAR PARTNERS, LLC


D/B/A INDIAN RIVER SOLAR FARM

6940 COLUMBIA GATEWAY DRIVE, SUITE 400

COLUMBIA, MD 21046

PREPARED BY: TRC ENGINEERS, INC.

DATE: JUNE 2022

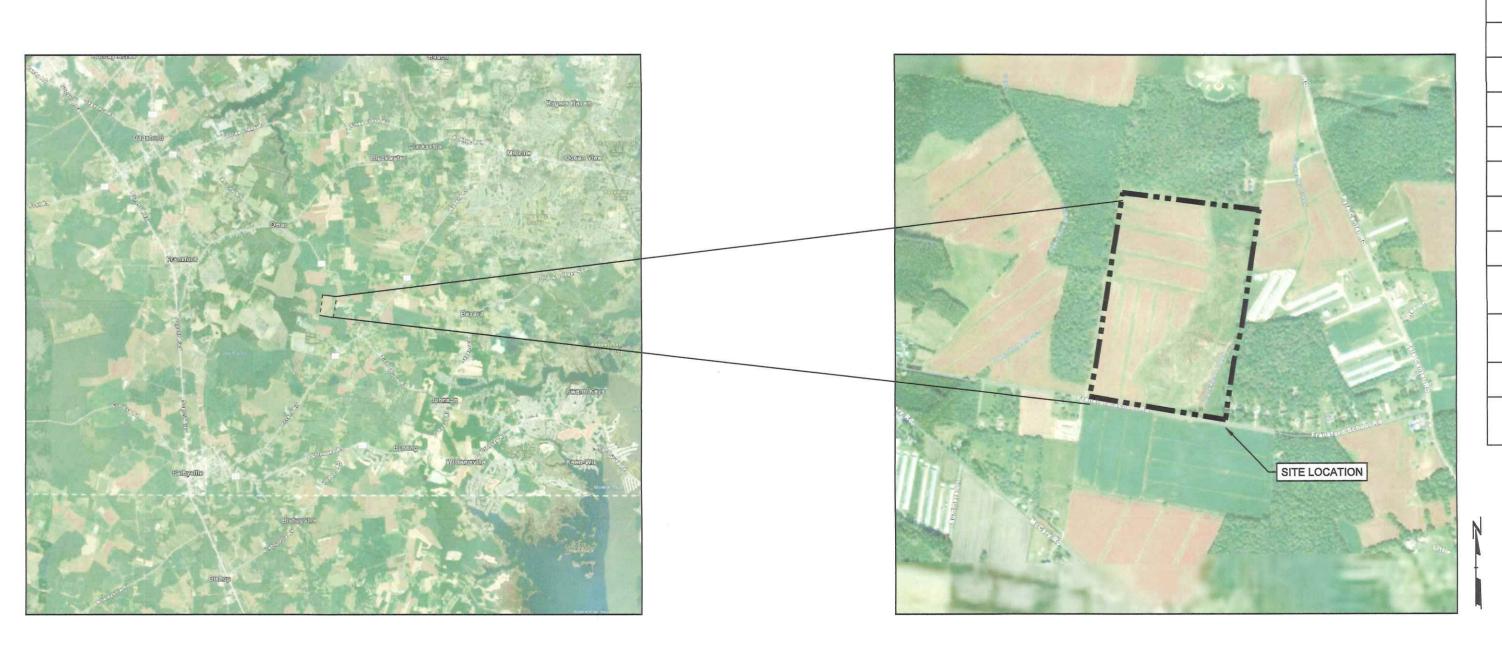

DRAWING INDEX		
SHEET NUMBER	SHEET TITLE	
C-1.0	COVER SHEET	
C-2.0	NOTES	
C-3.0	EXISTING CONDITIONS	
C-4.0	SITE PLAN	
C-4.1	SITE PLAN NORTH	
C-4.2	SITE PLAN SOUTH	
C-5.0	DETAILS	
C-6.0	DETAILS	
C-7.0	DETAILS	
	MRA STORMWATER PLANS	
1 OF 6	SEDIMENT AND STORMWATER COVER SHEET	
2 OF 6	CONSTRUCTION SITE STORMWATER MANAGEMENT PLAN	
3 OF 6	CONSTRUCTION SITE STORMWATER MANAGEMENT DETAILS AND NOTES	
4 OF 6	CONSTRUCTION SITE STORMWATER MANAGEMENT DETAILS AND NOTES	
5 OF 6	POST CONSTRUCTION STORMWATER MANAGEMENT PLAN	
6 OF 6	POST CONSTRUCTION STORMWATER MANAGEMENT DETAILS	

NO. BY DATE REVISION APP'D.

SUSSEX COUNTY

SITE LOCATOR



DELDOT GENERAL COMMERCIAL ENTRANCE NOTES

- ALL ENTRANCES SHALL CONFORM TO THE DELAWARE DEPARTMENT OF TRANSPORTATION'S (DELDOT'S) CURRENT DEVELOPMENT COORDINATION MANUAL AND SHALL BE SUBJECT TO ITS APPROVAL.
- ALL MATERIALS AND WORKMANSHIP WITHIN THE STATE OF DELAWARE RIGHT-OF-WAY SHALL BE IN ACCORDANCE WITH CURRENT STATE OF DELAWARE DEPARTMENT OF TRANSPORTATION STANDARD SPECIFICATIONS FOR ROAD AND BRIDGE CONSTRUCTION, SUPPLEMENTAL SPECIFICATIONS, STANDARD CONSTRUCTION DETAILS, SPECIAL PROVISIONS. PAS MANUAL AND DESIGN GUIDANCE MEMORANDUMS.
- ALL DISTURBED AREAS WITHIN THE STATE RIGHT-OF-WAY, BUT NOT IN THE PAVEMENT, SHALL BE TOP-SOILED (6" MINIMUM), FERTILIZED, SEEDED AND MULCHED. IF SOD IS USED NEXT TO SIDEWALK OR SHARED-USE PATH, CONTRACTOR SHALL GRADE TOPSOIL ADJACENT TO THE SIDEWALK OR SHARED-USE PATH PRIOR TO PLACEMENT OF SOD TO ENSURE THAT SOD IS PLACED FLUSH OR JUST BELOW EDGE OF SIDEWALK OR SHARED-USE PATH TO AVOID WATER PONDING ON THE SIDEWALK OR SHARED-USE PATH.
- A 72-HOUR (MINIMUM) NOTICE SHALL BE GIVEN TO THE DELDOT DISTRICT PERMIT SUPERVISOR PRIOR TO STARTING ENTRANCE CONSTRUCTION.
- MISS UTILITY OF DELAWARE SHALL BE NOTIFIED THREE (3) CONSECUTIVE WORKING DAYS PRIOR TO EXCAVATION, AT 1-800-282-8555.
- AT THE DISCRETION OF THE PUBLIC WORKS INSPECTOR, ANY DAMAGED OR MISSING CURB OR SIDEWALK FOUND ON SITE WILL NEED TO BE REPAIRED OR REPLACED TO MEET CURRENT DELDOT STANDARDS.
- ALL SIGNING, STRIPING AND MAINTENANCE OF TRAFFIC IS THE CONTRACTOR'S RESPONSIBILITY AND SHALL FOLLOW THE GUIDELINES SHOWN IN THE DELAWARE MANUAL ON UNIFORM TRAFFIC CONTROL DEVICES (DELAWARE MUTCD) FOR STREETS AND HIGHWAYS (LATEST EDITION AT THE DATE OF THE ENTRANCE PERMIT APPROVAL). THE DEVELOPER OR PROPERTY OWNERS SHALL BE RESPONSIBLE FOR MAINTENANCE OF ALL SIGNS INSTALLED AS PART OF THIS PROJECT.
- 8. PLAN LOCATION AND DIMENSIONS SHALL BE STRICTLY ADHERED TO UNLESS OTHERWISE DIRECTED BY THE DELDOT INSPECTOR.
- A COPY OF THE-UP-TO DATE APPROVED CONSTRUCTION DOCUMENTS AND DELDOT APPROVAL LETTERS SHALL BE MAINTAINED ON THE PROJECT SITE AT ALL TIMES AND BE AVAILABLE FOR INSPECTION BY DELDOT PERSONNEL.
- 10. UPON COMPLETION OF THE CONSTRUCTION OF THE SIDEWALK OR SHARED-USE PATH ACROSS THIS PROJECT'S FRONTAGE AND PHYSICAL CONNECTION TO ADJACENT EXISTING FACILITIES, THE DEVELOPER, THE PROPERTY OWNERS OR BOTH ASSOCIATED WITH THIS PROJECT, SHALL BE RESPONSIBLE TO REMOVE ANY EXISTING ROAD TIE-IN CONNECTIONS LOCATED ALONG ADJACENT PROPERTIES, AND RESTORE THE AREA TO GRASS. THESE DISTURBED AREAS SHALL BE TOP-SOILED (6" MINIMUM), FERTILIZED, SEEDED AND MULCHED. SUCH ACTIONS SHALL BE COMPLETED AT DELDOT'S DISCRETION, AND IN CONFORMANCE WITH THE DEVELOPMENT COORDINATION MANUAL.
- DELDOT WILL NOT PROVIDE THE RESPECTIVE LOCAL LAND USE AGENCY WITH A 'NO OBJECTION TO THE ISSUANCE OF THE CERTIFICATE OF OCCUPANCY NOTICE' UNTIL THE ENTRANCE(S) ARE COMPLETED TO THE SATISFACTION OF
- DESIGN, FABRICATION AND INSTALLATION OF ALL PERMANENT SIGNING SHALL BE AS OUTLINED IN THE LATEST VERSION OF THE DELAWARE MUTCD.
- 13. DESIGN AND INSTALLATION OF ALL PAVEMENT MARKINGS AND STRIPING SHALL BE AS OUTLINED IN THE LATEST VERSION OF THE DELAWARE MUTCD. FOR FINAL PERMANENT PAVEMENT MARKINGS:
- EPOXY RESIN PAINT SHALL BE REQUIRED FOR LONG LINE STRIPING.
- THERMO PLASTIC (EXTRUDED OR PREFORMED MATERIAL) WILL BE REQUIRED ON ASPHALT SURFACES, FOR SHORT LINE STRIPING, I.E. SYMBOLS/LEGENDS.
- PERMANENT PAVEMENT MARKING TAPE (PER DELDOT'S APPROVED MATERIALS LIST) WILL BE REQUIRED ON CONCRETE SURFACES, FOR SHORT LINE STRIPING, I.E. SYMBOLS/LEGENDS
- 14. REMOVAL OF PAVEMENT MARKING PAINT OR TAPE SHALL COMPLY WITH SECTION 5.11.2 OF THE DEVELOPMENT COORDINATION MANUAL.
- 15. BREAKAWAY POSTS SHALL BE USED WHEN INSTALLING ALL SIGNS. REFERENCE DELDOT'S STANDARD
- 16. ALL FIXED OBJECTS ARE TO BE A MINIMUM OF 10-FEET FROM THE EDGE OF TRAVEL LANE AND 5-FEET FROM THE EDGE OF PAVEMENT. REFERENCE SECTION 5.5.5 OF THE DEVELOPMENT COORDINATION MANUAL. ANY FIXED OBJECT THAT DOES NOT MEET THIS REQUIREMENT SHALL BE RELOCATED.
- 17. IT IS THE CONTRACTOR'S RESPONSIBILITY TO ENSURE THAT ALL PAVING WITHIN THE STATE OF DELAWARE RIGHT-OF-WAY IS INSTALLED IN SUCH A WAY THAT NO PONDING OF WATER EXISTS AFTER PAVING IS COMPLETE.
- 18. ALL STORM DRAIN PIPING DESIGNATED AS REINFORCED CONCRETE PIPE IS TO BE REINFORCED CONCRETE PIPE, MEETING AASHTO M-170 SPECIFICATIONS. SEE PLANS FOR SPECIFIC CLASS OF PIPE.
- 19. ALL SUBGRADE SHALL BE COMPACTED TO 95% OF THE MAXIMUM STANDARD T-99 DRY DENSITY.

MAINTENANCE OF TRAFFIC NOTES

- ALL TEMPORARY TRAFFIC CONTROL AND TEMPORARY TRAFFIC CONTROL DEVICES SHALL BE IN ACCORDANCE WITH: THE CONTRACT DOCUMENTS, THE LATEST VERSION OF THE DELAWARE MANUAL ON UNIFORM TRAFFIC CONTROL DEVICES (HEREINAFTER REFERRED TO AS THE "DELAWARE MUTCD"), CURRENT STATE OF DELAWARE DEPARTMENT OF TRANSPORTATION STANDARD SPECIFICATIONS FOR ROAD AND BRIDGE CONSTRUCTION, AND SUPPLEMENTAL SPECIFICATIONS, INCLUDING ALL REVISIONS AS OF THE DATE OF THE ENTRANCE PERMIT APPROVAL.
- THE DEPARTMENT RESERVES THE RIGHT TO STOP THE CONTRACTOR'S OPERATIONS, IF, IN THE OPINION OF THE DEPARTMENT'S REPRESENTATIVE, THE CONTRACTOR'S OPERATIONS ARE NOT IN COMPLIANCE WITH THE DELAWARE MUTCD, THE SPECIFICATIONS OR THE PLANS OR IF THE CONTRACTOR'S OPERATIONS ARE DEEMED UNSAFE.
- THE CONTRACTOR SHALL BE RESPONSIBLE FOR ENSURING THAT THE TRANSPORTATION MANAGEMENT CENTER IS NOTIFIED EACH AND EVERY DAY WHEN WORK IS BEING PERFORMED IN STATE RIGHT-OF-WAY. THE CONTRACTOR SHALL IDENTIFY THE TYPE OF WORK, ANY LANE(S) OR SHOULDER(S) CLOSED, THE LENGTH OF TIME FOR WORK, WHEN THE LANE RESTRICTIONS ARE IN PLACE AND WHEN LANE RESTRICTIONS ARE LIFTED, CONTACT PERSON/PHONE NUMBER AND STATE INSPECTOR. THE TRANSPORTATION MANAGEMENT CENTER CAN BE REACHED AT (302) 659-4600.
- ALL PAVEMENT MARKINGS THAT ARE NO LONGER IN USE AND CONFLICT WITH TEMPORARY PAVEMENT MARKINGS SHALL BE REMOVED AND COMPLETELY OBLITERATED BY A METHOD APPROVED BY THE ENGINEER. PAINTING OVER THE CONFLICTING PAVEMENT MARKINGS WILL NOT BE ACCEPTED AS A METHOD OF REMOVAL.
- THE CONTRACTOR SHALL BE RESPONSIBLE FOR NOTIFYING THE LOCAL 911 CENTER, LOCAL SCHOOLS AND DELDOT COMMUNITY RELATIONS OF ALL ROADS AND LANES TO BE CLOSED A MINIMUM OF SEVEN (7) CALENDAR DAYS BEFORE THE CLOSURE.
- ALLOWABLE LANE CLOSURE HOURS SHALL BE IN ACCORDANCE WITH P.I. NUMBER C-09, PLANNED LANE RESTRICTION AND ROAD CLOSURE POLICY, UNLESS DIRECTED OTHERWISE BY DELDOT TRAFFIC SAFETY.
- THE CONTRACTOR SHALL PROVIDE PEDESTRIAN MAINTENANCE OF TRAFFIC IN ACCORDANCE WITH THE DELAWARE MUTCD DURING CONSTRUCTION ACTIVITIES THAT IMPACT EXISTING PEDESTRIAN FACILITIES.
- ACCEPTABLE MATERIALS FOR TEMPORARY PEDESTRIAN PATHS SHALL INCLUDE CONCRETE, HOT-MIX, COMPACTED MILLINGS OR PLYWOOD WALKWAY STRUCTURE. PLYWOOD WALKWAY STRUCTURES SHALL ALSO INCLUDE DETECTABLE EDGING AND RAILINGS IN ACCORDANCE WITH ADA GUIDELINES AND THE DELAWARE MUTCD. STONE OR GRADED AGGREGATE BASE COURSE SHALL NOT BE USED FOR TEMPORARY PEDESTRIAN PATHS.
- ALL STORAGE OF EQUIPMENT AND MATERIAL SHALL COMPLY WITH THE DELAWARE MUTCD, SECTION 6G.21.
- 10. THE CONTRACTOR IS RESPONSIBLE FOR THE MAINTENANCE OF EXISTING PAVEMENT WITHIN THE PROJECT LIMITS FOR THE DURATION OF THE CONTRACT OR AS DIRECTED BY THE ENGINEER.

CIVIL NOTES:

- THE CONTRACTOR SHALL ABIDE BY LOCAL, STATE, AND FEDERAL LAWS, RULES AND REGULATIONS WHICH APPLY TO THE CONSTRUCTION OF THESE IMPROVEMENTS
- PRIOR TO CONSTRUCTION, THE CONTRACTOR SHALL FIELD VERIFY EXISTING CONDITIONS AGAINST THE PROVIDED SURVEY INCLUDING THE HORIZONTAL AND VERTICAL LOCATIONS OF POTENTIAL OBSTRUCTIONS INCLUDING UNDERGROUND UTILITIES. SHOULD A CONFLICT EXIST, THE CONTRACTOR SHALL NOTIFY THE OWNER AND ENGINEER SO THAT THE CONFLICT CAN BE RESOLVED WITH MINIMAL DELAYS.
- LOCATION OF EXISTING UTILITIES SHOWN ON PLANS WAS COMPILED FROM RECORD INFORMATION. NO WARRANTY IS IMPLIED AS TO THE ACTUAL LOCATION OF EXISTING UTILITIES. CONTRACTOR TO FIELD VERIFY LOCATIONS OF EXISTING UTILITIES PRIOR TO COMMENCEMENT OF CONSTRUCTION. THE CONTRACTOR IS RESPONSIBLE FOR LOCATING UNDERGROUND FEATURES. THE CONTRACTOR SHALL CONTACT UTILITY LOCATING SERVICE THREE (3) WORKING DAYS PRIOR TO EXCAVATION. ADDITIONALLY, CONTRACTOR SHALL CONTACT LOCAL UTILITIES THAT PROVIDE THEIR OWN LOCATOR SERVICES.
- ELECTRICAL, TELEPHONE, CABLE TV, GAS, AND OTHER UTILITY LINES, CABLES AND APPURTENANCES ENCOUNTERED DURING CONSTRUCTION THAT REQUIRE RELOCATION SHALL BE COORDINATED WITH THAT UTILITY. CONTRACTOR SHALL BE RESPONSIBLE FOR COORDINATION OF NECESSARY UTILITY ADJUSTMENTS. NO ADDITIONAL COMPENSATION WILL BE ALLOWED FOR DELAY OR INCONVENIENCES CAUSED BY UTILITY COMPANY WORK CREWS. CONTRACTOR MAY BE REQUIRED TO RESCHEDULE THEIR ACTIVITIES TO ALLOW UTILITY CREWS TO PERFORM THEIR REQUIRED WORK.
- CONTRACTOR IS RESPONSIBLE FOR PROTECTING EXISTING UTILITY LINES WITHIN THE CONSTRUCTION AREA. DAMAGE TO EXISTING UTILITY LINES CAUSED BY CONSTRUCTION ACTIVITIES SHALL BE REPAIRED OR REPLACED AT THE CONTRACTOR'S
- CONSTRUCTION SHALL NOT OCCUR IN PUBLIC RIGHTS OF WAY, PUBLIC OR PRIVATE EASEMENTS, BEYOND THE LIMITS OF DISTURBANCE, OR OUTSIDE THE LEASE AREA WITHOUT A PERMIT. PUBLIC OR PRIVATE PROPERTY OR IMPROVEMENTS DAMAGED DURING CONSTRUCTION SHALL BE REPAIRED TO THE SATISFACTION OF THE OWNER AT THE COST OF THE CONTRACTOR.
- OVERNIGHT PARKING OF CONSTRUCTION EQUIPMENT SHALL NOT OBSTRUCT DRIVEWAYS OR DESIGNATED TRAFFIC LANES. THE CONTRACTOR SHALL NOT STORE EQUIPMENT OR MATERIAL WITHIN PUBLIC RIGHTS-OF-WAY. OVERNIGHT PARKING OF CONSTRUCTION VEHICLES ON PRIVATE PROPERTY IS THE SOLE RESPONSIBILITY OF THE CONTRACTOR.
- THE CONTRACTOR SHALL OBTAIN THE NECESSARY PERMITS FOR THE PROJECT PRIOR TO COMMENCING CONSTRUCTION (E.G., BARRICADING, TOPSOIL DISTURBANCE, EXCAVATION, SHORING, ETC.).
- PROPERTY CORNERS DESTROYED DURING CONSTRUCTION SHALL BE REPLACED AT THE CONTRACTOR'S EXPENSE. PROPERTY CORNERS MUST BE RESET BY A REGISTERED LAND SURVEYOR.
- 10. THE CONTRACTOR SHALL BE FULLY RESPONSIBLE TO PROVIDE SIGNS, BARRICADES, WARNING LIGHTS, GUARD RAILS, AND EMPLOY FLAGGERS AS NECESSARY WHEN CONSTRUCTION INTERFERES WITH EITHER VEHICULAR OR PEDESTRIAN TRAFFIC. THESE DEVICES SHALL REMAIN IN PLACE UNTIL THE TRAFFIC MAY PROCEED NORMALLY AGAIN.
- 11. BARRICADES AND CONSTRUCTION SIGNING SHALL CONFORM TO THE APPLICABLE SECTION OF THE "MANUAL ON UNIFORM TRAFFIC CONTROL DEVICES" (MUTCD), U.S. DEPARTMENT OF TRANSPORTATION, LATEST EDITION.
- 12. CONTRACTOR SHALL COMPLY WITH FEDERAL, STATE, AND LOCAL LAWS AND REGULATIONS CONTROLLING POLLUTION OF THE ENVIRONMENT PRIOR TO THE START OF THE PROJECT CONSTRUCTION. THE CONTRACTOR SHALL ABIDE BY THE PERMITS OBTAINED BY OWNER. CONTRACTOR SHALL OBTAIN AND BE RESPONSIBLE FOR PERMITS REQUIRED BY THE CONTRACT DOCUMENTS.
- BEFORE COMMENCING CONSTRUCTION, THE CONTRACTOR SHALL LOCATE, POTHOLE AND MEASURE DEPTH TO TOP OF EXISTING, UNDERGROUND WET & DRY UTILITIES AT PROPOSED CROSSING LOCATIONS, ACCORDING TO THE CONTRACT DOCUMENTS OR AS SPECIFIED BY THE UTILITY OWNER. CONTRACTOR SHALL PROVIDE ENGINEER AND OWNER WITH AN "AS-BUILT" PLAN OF INFORMATION, AND RECEIVE FORMAL APPROVAL BEFORE STARTING WORK.
- CONTRACTOR TO PERFORM WORK IN ACCORDANCE WITH EXISTING PROJECT PERMITS, STUDIES, AND REPORTS PROVIDED IN THE CONTRACT DOCUMENTS INCLUDING: CONDITIONAL USE, SPECIAL USE, OR OTHER LAND USE TYPE PERMITS INCLUDING THE ASSOCIATED CONDITIONS OF APPROVAL; ENVIRONMENTAL STUDIES AND REPORTS; HYDROLOGICAL STUDIES AND REPORTS; ETC.
- 15. CONTRACTOR SHALL DETERMINE THE SOURCE OF AND SECURE APPROVAL OF CONSTRUCTION WATER AS NECESSARY TO COMPLETE THE PROJECT.
- 16. CONTRACTOR SHALL MANAGE DUST, DIRT, MUD, SNOW, ETC. DURING THE CONSTRUCTION PHASE IN A SUITABLE MANNER SO AS TO NOT TO IMPACT THE COMMISSIONING, PERFORMANCE, INSPECTION, OR RELIABILITY OF EQUIPMENT, SUCH AS BUT NOT LIMITED TO: MODULES, COMBINERS, INVERTERS, TRANSFORMERS, DISCONNECTS, SWITCHGEAR, SCADA / SEEDS, WEATHER STATIONS, CONDUCTORS AND TERMINATIONS, AND TRACKERS.
- 17. THIS PROJECT DOES NOT PROPOSE NEW WATER OR SANITARY SEWER FACILITIES.
- 18. THE LOCATIONS OF PROPOSED IMPROVEMENTS, INCLUDING BUT NOT LIMITED TO: FENCING, SOLAR ARRAY RACKING, INVERTER/TRANSFORMER STRUCTURES, OVERHEAD POLES AND LINES, ETC., SHOWN ARE APPROXIMATE AND ARE SUBJECT TO MODIFICATION DUE TO SITE CONDITIONS, ADDITIONAL PERMITTING REQUIREMENTS, EQUIPMENT SPECIFICATIONS, AND/OR OTHER CONSTRAINTS.
- 19. PROJECT AREA, INCLUDING CONSTRUCTION STAGING AREAS, WILL BE CLEARED AND GRUBBED AS NECESSARY, RETAINING PRE-DEVELOPMENT DRAINAGE PATTERNS TO THE MAXIMUM EXTENT POSSIBLE. CONSTRUCTION STAGING AND AREAS SUBJECT TO RUTTING DURING CONSTRUCTION WILL BE TEMPORARILY STABILIZED WITH GRAVEL OR OTHER MATERIAL APPROVED BY OWNER.
- 20. THE CONTRACTOR SHALL PROVIDE GENERATORS TO SUPPLY POWER FOR ACTIVITIES RELATED TO CONSTRUCTION. GENERATORS AND TEMPORARY PUMPS TO BE LOCATED IN CONTRACTOR-PROVIDED TEMPORARY SECONDARY CONTAINMENT.
- 21. CONTRACTOR SHALL MAINTAIN ACCESS AND UTILITY SERVICES TO EXISTING BUILDING(S) OR ADJACENT BUILDING(S) THROUGHOUT THE PROPOSED PROJECT. EXISTING IMPROVEMENTS DAMAGED DURING CONSTRUCTION SHALL BE REPLACED/RESTORED TO THE SATISFACTION OF THE OWNER BY THE CONTRACTOR RESPONSIBLE FOR THE DAMAGE.

SITE MAINTENANCE NOTES:

PROJECT OWNER TO MAINTAIN VEGETATION TO APPROXIMATELY 5 FEET OUTSIDE THE PROPOSED PERIMETER FENCELINE. THE REMAINDER OF THE PROPERTY IS NOT UNDER CONTROL OF THE PROJECT OWNER (I.E., OUTSIDE THE LEASEHOLD) AND WILL REMAIN IN THE CONTROL OF THE PROPERTY OWNER; MOST LIKELY TO CONTINUE TO BE FARMED.

GRADING NOTES:

- ALL NOTES HEREIN RELATED TO GRADING ARE FOR INSTALLATION OF THE ACCESS ROAD AND PROPOSED UTILITIES. OTHERWISE NO GRADING IS REQUIRED FOR THIS SITE AND THE POST-DEVELOPMENT GRADES WILL REMAIN CONSISTENT WITH THE
- WORK RELATED TO ROAD CONSTRUCTION, SITE PREPARATION, AND GRAVEL INSTALLATION, AS SHOWN ON THIS PLAN, SHALL, UNLESS OTHERWISE STATED OR PROVIDED FOR HEREON, BE CONSTRUCTED IN ACCORDANCE WITH THE PROJECT SPECIFICATION AND STATE OR LOCAL STANDARD SPECIFICATIONS.
- THE CONTRACTOR SHALL NOT PERFORM WORK OUTSIDE OF THE LIMITS OF DISTURBANCE EXCEPT AS REQUIRED BY THIS PLAN.
- EXCAVATED MATERIAL (NON-HAZARDOUS OR NON-CONTAMINATED) MAY BE TEMPORARILY STOCKPILED IN AREAS DESIGNATED BY OWNER. TOPSOIL TO BE STOCKPILED SEPARATELY. EXCESS EXCAVATED MATERIAL CAN BE SPREAD ONSITE. CATWALK THE SPREAD MATERIAL USING DIRECTIONAL TRACKING PRACTICES, APPLY TOPSOIL, AND VEGETATE AREAS IN ACCORDANCE WITH THE EROSION AND SEDIMENTATION CONTROL PLAN.
- EXCESS MATERIAL REMOVED FROM THE SITE SHALL BE DISPOSED OF IN ACCORDANCE WITH REGULATORY AUTHORITIES. CONTRACTOR SHALL NOTIFY THE OWNER'S REPRESENTATIVE AND STATE AUTHORITIES OF LOCATION OF DISPOSAL BEFORE MATERIAL IS REMOVED.
- A DISPOSAL SITE FOR EXCESS EXCAVATION MATERIAL AND UNSUITABLE MATERIAL AND/OR A BORROW SITE CONTAINING ACCEPTABLE FILL MATERIAL SHALL BE OBTAINED BY THE CONTRACTOR IN COMPLIANCE WITH APPLICABLE ENVIRONMENTAL REGULATIONS AND APPROVED BY THE OWNER.
- FILL MATERIAL SHALL NOT CONTAIN DELETERIOUS MATERIALS OR ORGANIC MATTER. FROZEN AND FROST HEAVED SOIL IS NOT SUITABLE FOR FILL. NO ROCK OR IRREDUCIBLE MATERIAL WITH A MINIMUM DIMENSION GREATER THAN 2 INCHES SHALL BE BURIED OR PLACED AS FILL UNLESS SPECIFIED OTHERWISE.
- CONDUCT EARTHWORK OPERATIONS ONLY IN AREA REQUIRED FOR IMMEDIATE CONSTRUCTION ACTIVITY AND THEN ONLY IF SEDIMENT CONTROL DEVICES ARE IN PLACE. MASS CLEARING AND GRADING OF THE SITE SHALL BE AVOIDED IN AREAS BELOW FOUNDATIONS SUPPORTED ON SOIL, SOIL/FILL SHOULD BE COMPACTED TO 95% OF THE MAXIMUM DRY UNIT WEIGHT DETERMINED BY THE STANDARD PROCTOR TEST AT A MOISTURE CONTENT WITHIN 2% OF THE OPTIMUM

- MOISTURE CONTENT. COMPACT AGGREGATE AND GRAVEL TO THE SAME REQUIREMENTS OF FILL TO THE GRADES AND SLOPES SHOWN ON DRAWINGS. IN OTHER AREAS WITHOUT COMPACTION OR PROOF ROLLING CRITERIA, SOIL/FILL SHOULD BE COMPACTED TO A MINIMUM 90% OF THE MAXIMUM DRY UNIT WEIGHT DETERMINED BY THE STANDARD PROCTOR TEST.
- 10. PRIOR TO PROOF ROLLING, COMPACT SURFACE WITH A SMOOTH-DRUM COMPACTOR IMMEDIATELY PRIOR TO PROOF ROLLING TO ENSURE THE SURFACE IS FREE OF TRACKS, RUTS, AND RIDGED MATERIAL TO PREVENT FALSE READINGS. PROVIDE DOCUMENTATION OF THE WEIGHT OF THE LOADED TRUCK TO THE ENGINEER. PROOF ROLLING SHALL BE PERFORMED IN THE PRESENCE OF THE GEOTECHNICAL ENGINEER OR QUALIFIED GEOTECHNICAL REPRESENTATIVE USING A FULLY LOADED TANDEM AXLE DUMP TRUCK WITH A MINIMUM GROSS WEIGHT OF 25 TONS OR A FULLY LOADED WATER TRUCK WITH AN EQUIVALENT AXLE LOADING. PROOF ROLLING SHOULD BE CONDUCTED IN A MANNER SUCH THAT AFTER THE FIRST PASS SUBSEQUENT PASSES WILL HAVE ONE WHEEL CENTERED BETWEEN THE WHEEL PATHS OF THE PREVIOUS PASS, UNTIL THE ENTIRE SURFACE OF THE PROOF ROLL AREA IS TESTED. PROOF ROLLING ACCEPTANCE STANDARDS INCLUDE NO RUTTING GREATER THAN TWO INCHES, AND NO DEFLECTIONS (PUMPING) BEHIND THE LOADED TRUCK.
- 11. THESE RECOMMENDATIONS SHALL BE SUBJECT TO REINTERPRETATION FOLLOW RECEIPT OF GEOTECHNICAL INVESTIGATION REPORT.

REQUIREMENTS:

COMPACTED SUBGRADE:

 THE ENTIRE ACCESS DRIVE SUBGRADE SHALL BE PROOF-ROLLED PRIOR TO THE PLACEMENT OF THE GEOTEXTILE AND AGGREGATE TO IDENTIFY AREAS OF UNSTABLE SUBGRADE. IF UNSTABLE SUBGRADE IS ENCOUNTERED SCARIFY, MOISTURE CONDITION, AND RECOMPACT SOILS TO ACHIEVE COMPACTION.

AGGREGATE BASE AND SUBBASE:

- AGGREGATE BASE SHALL BE PROOF ROLLED OVER THE ENTIRE LENGTH. IF PROOF ROLLING DETERMINES THAN THE DRIVE IS UNSTABLE, ADDITIONAL AGGREGATE SHALL BE ADDED UNTIL THE UNSTABLE SECTION IS ABLE TO PASS A PROOF ROLL.
- PROVIDE SIEVE ANALYSIS PER 2,000 CUBIC YARDS OF AGGREGATE PLACED.




ISSUED FOR PRELIMINARY SITE Know what's below. PLAN APPROVAL. NOT FOR CONSTRUCTION.

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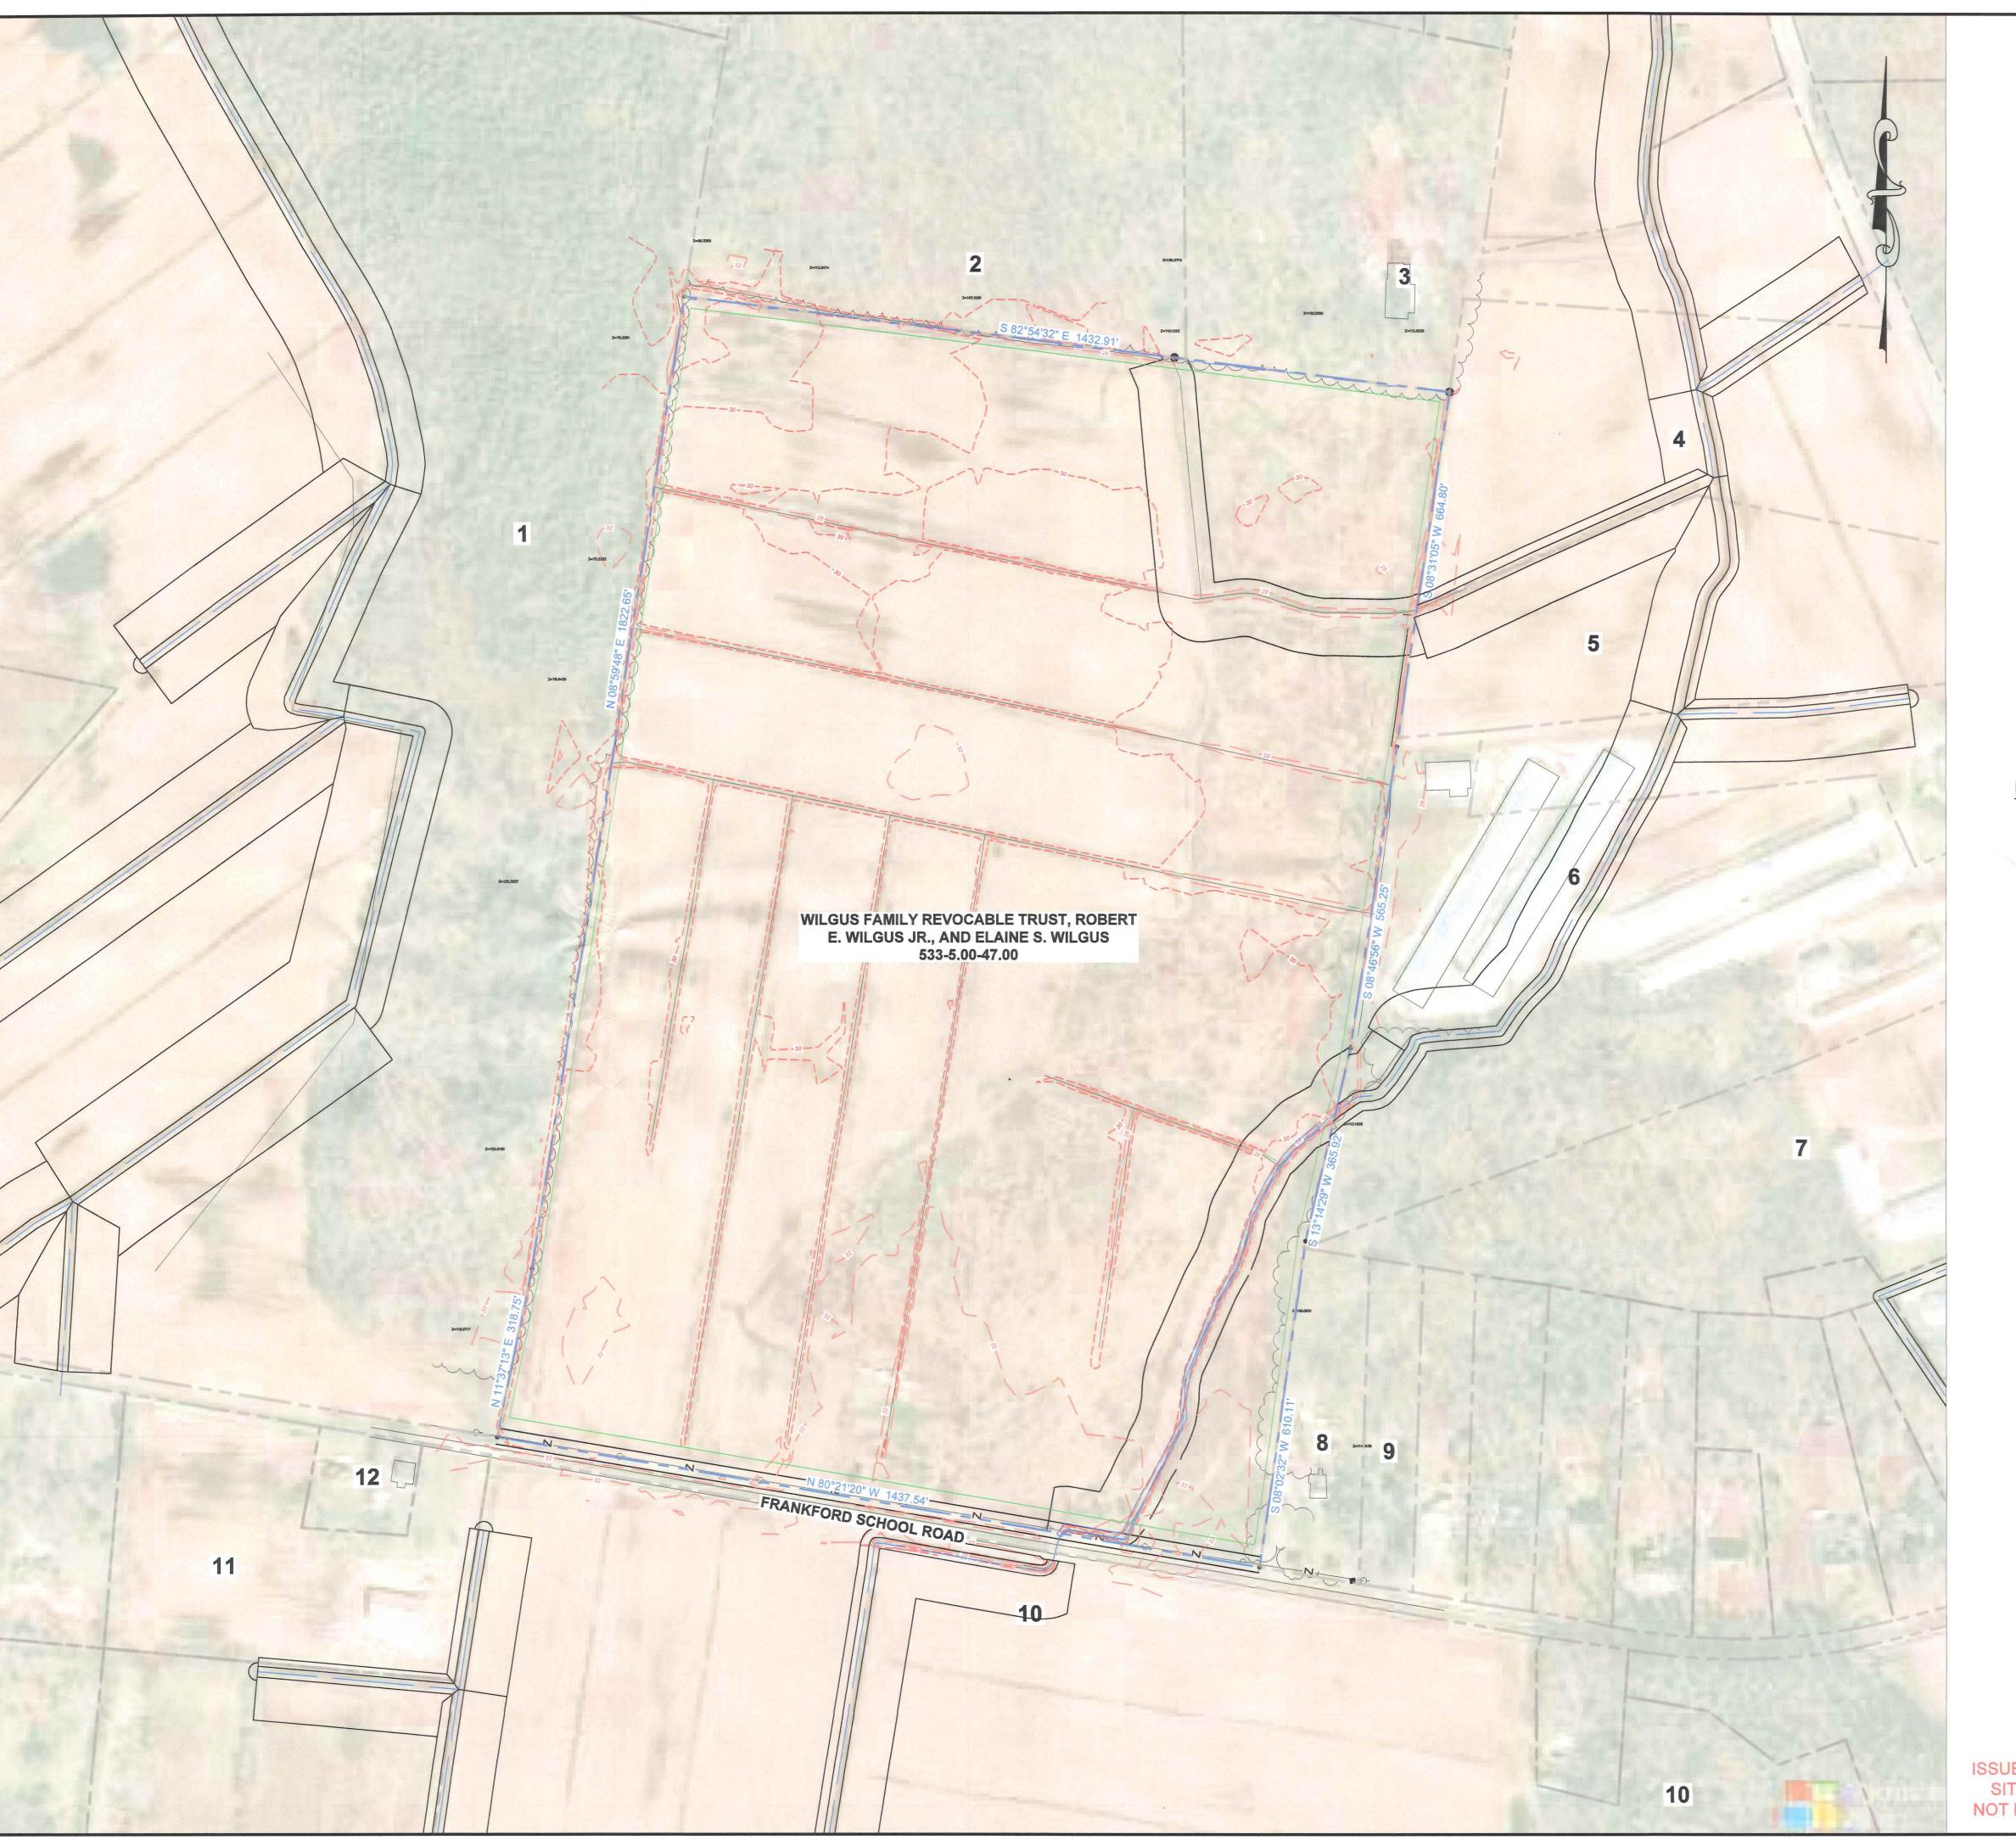
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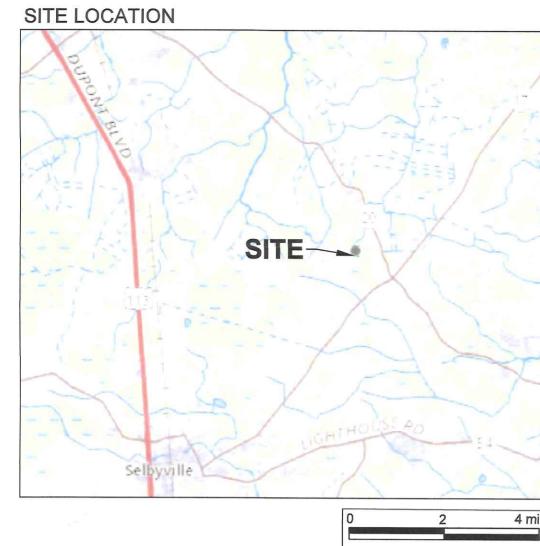
Scale: AS NOTED Date:

JUNE 2022 Sheet:

NOTES Drawing No:

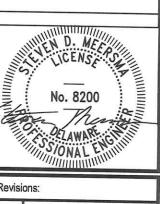C-2.0





LEGEND

DESCRIPTION -----55-----EXISTING MAJOR CONTOUR (FEET)

EXISTING PROPERTY LINE APPROXIMATE EXISTING ABUTTER PROPERTY LINE TAX DITCH RIGHT-OF-WAY LIMIT

YARD SETBACK LINE

EXISTING MINOR CONTOUR (FEET)

WATERWAY/DITCH FLOWLINE

NOTES

- 1. THE PROJECT HORIZONTAL COORDINATES SYSTEM IS BASED ON NAD83 DELAWARE STATE PLANE (US SURVEY FEET). ELEVATIONS ARE BASED ON NAVD88 (US SURVEY FEET).
- 2. ADJOINING PROPERTY OWNER INFORMATION SHOWN ARE FROM SUSSEX COUNTY GIS PORTAL. (HTTPS://MAPS.SUSSEXCOUNTYDE.GOV/PZAPPLICATIONS/MAP.HTML)
- 3. SITE IS NOT LOCATED IN A 100-YEAR OR 500-YEAR FLOOD PLAIN (REFERENCE FLOOD INSURANCE RATE MAP.
- 4. EXISTING UTILITIES ARE APPROXIMATE AND SHOULD BE VERIFIED BY CONTRACTOR. DIG SAFELY DELAWARE (811) SHALL BE NOTIFIED A MINIMUM OF 72-HOURS PRIOR TO COMMENCING ANY EXCAVATION.
- 5. THIS IS A PRELIMINARY DESIGN PLAN PROVIDED FOR PERMITTING ONLY. FINAL DESIGN SHALL BE MODIFIED TO SUPPORT CONSTRUCTION, MATCH FINAL ELECTRICAL INTERCONNECTION STUDIES, EQUIPMENT PURCHASED, AND POSSIBLE PERMIT CONSTRAINTS REVEALED DURING PROJECT'S
- 6. THE VICINITY MAP IMAGE IS FROM THE UNITED STATES GEOLOGICAL SURVEY 7.5 MINUTE FRANKFORD AND SELBYVILLE TOPGRAPHIC
- 7. THE 1-FOOT TOPOGRAPHY AND PROPERTY BOUNDARY SHOWN ON THESE DRAWINGS WERE PROVIDED TO TRC BY GREENMAN-PEDERSEN, INC. ON JANUARY 19, 2022.

	ADJOINING PROPERTY OWNER INFORMATION TABLE		
NUMBER	PROPERTY OWNER	TAX ID#	
1	DAVIDSON GORDON C TTEE	533-5.00-46.00	
2	PYLE EDWARD W CENTER	533-5.00-58.00	
3	LYNCH ADAM	533-5.00-57.00	
4	LYNCH MARY GRACE	533-5.00-56.02	
5	LYNCH MICHAEL W	533-5.00-56.01	
6	OWENS FRANCES	533-5.00-55.01	
7	ENNIS N MICHAEL LISA E EVANS	533-5.00-55.00	
8	ESHAM MICHAEL	533-5.00-48.00	
9	KEISER CARVEL	533-5.00-49.03	
10	PARKER FAMILY LIMITED PARTNERSHIP	533-5.00-85.00	
11	MEIKLEJOHN JERRY TTEE REV TR	533-5.00-86.00	
12	BUNDICK SIDNEY R	533-5.00-86.02	

ISSUED FOR PRELIMINARY SITE PLAN APPROVAL NOT FOR CONSTRUCTION.

SHEET SIZE: 24" BY 36" (DRAWING MAY BE PRINTED AT REDUCED SIZE)

SCALE: 1" = 150'





EK, CV, AR

Design by:

Checked by:


Contract No: 376627 Scale:

AS NOTED Date: JUNE 2022

Sheet: EXISTING CONDITIONS

Drawing No:

C-3.0

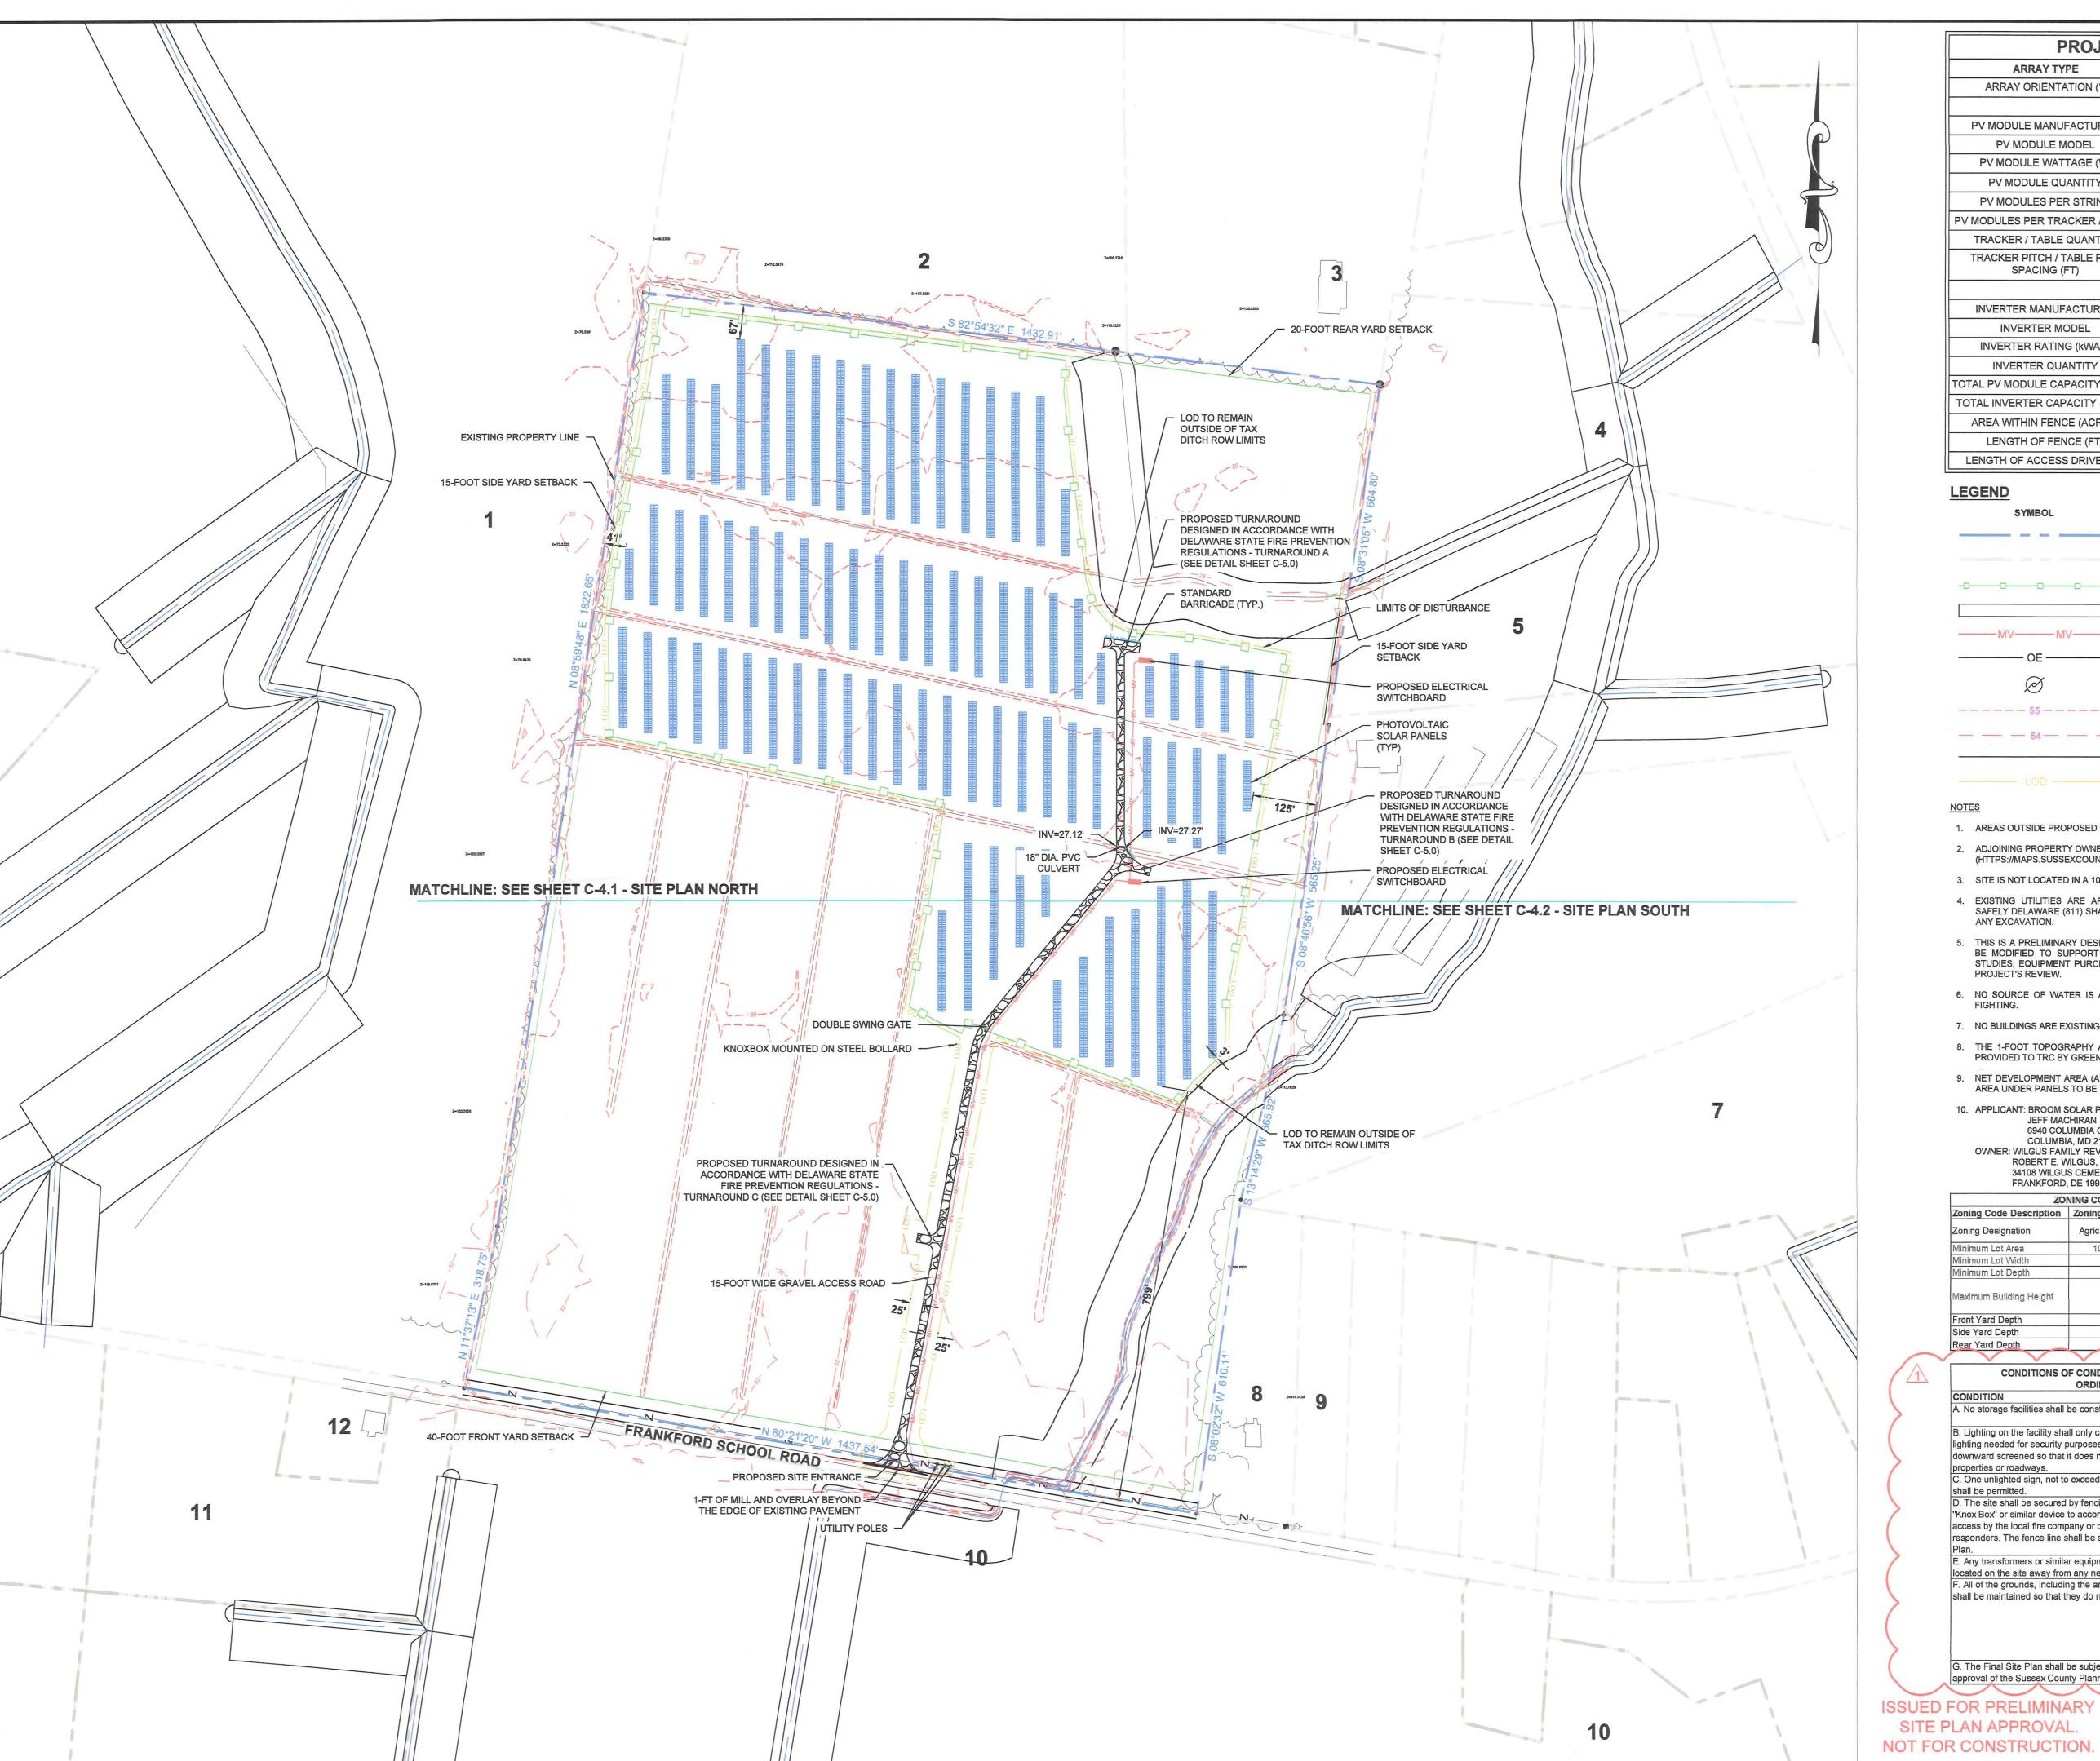

PROJECT	SUMMARY	
ARRAY TYPE	SAT	
ARRAY ORIENTATION (°)	18	30
	PV MODULE 1	PV MODULE 2
PV MODULE MANUFACTURER	CANADIA	N SOLAR
PV MODULE MODEL	CS3W-445-MB-AG	CS3W-400-PB-AG
PV MODULE WATTAGE (W)	445	400
PV MODULE QUANTITY	6,966	2,322
PV MODULES PER STRING	2	7
PV MODULES PER TRACKER / TABLE	54 / 72	
TRACKER / TABLE QUANTITY	168 / 12	
TRACKER PITCH / TABLE ROW SPACING (FT)	48.27	
	INVERTER 1	INVERTER 2
INVERTER MANUFACTURER	CHINT POWE	ER SYSTEMS
INVERTER MODEL	SCH125KTL-DO/US-600	
INVERTER RATING (kWAC)	125	
INVERTER QUANTITY	24	
TOTAL PV MODULE CAPACITY (kWDC)	4,028.67	
TOTAL INVERTER CAPACITY (kWAC)	3,000	
AREA WITHIN FENCE (ACRES)	26.87	
LENGTH OF FENCE (FT)	5,033	
LENGTH OF ACCESS DRIVE (FT)	1,7	10

DESCRIPTION EXISTING PROPERTY LINE APPROXIMATE EXISTING ABUTTER PROPERTY LINE PROPOSED PROJECT FENCE PROPOSED GRAVEL ACCESS DRIVEWAY PROPOSED MEDIUM VOLTAGE CIRCUIT PROPOSED OVERHEAD LINE PROPOSED OVERHEAD POLES EXISTING MAJOR CONTOUR (FEET) ----- 55 -----EXISTING MINOR CONTOUR (FEET) TAX DITCH RIGHT-OF-WAY LIMIT LIMITS OF DISTURBANCE

- 1. AREAS OUTSIDE PROPOSED FENCE TO REMAIN AS OPEN SPACE.
- 2. ADJOINING PROPERTY OWNER INFORMATION SHOWN ARE FROM SUSSEX COUNTY GIS PORTAL. (HTTPS://MAPS.SUSSEXCOUNTYDE.GOV/PZAPPLICATIONS/MAP.HTML)
- 3. SITE IS NOT LOCATED IN A 100-YEAR OR 500-YEAR FLOOD PLAIN.
- 4. EXISTING UTILITIES ARE APPROXIMATE AND SHOULD BE VERIFIED BY CONTRACTOR. DIG SAFELY DELAWARE (811) SHALL BE NOTIFIED A MINIMUM OF 72-HOURS PRIOR TO COMMENCING ANY EXCAVATION.
- 5. THIS IS A PRELIMINARY DESIGN PLAN PROVIDED FOR PERMITTING ONLY. FINAL DESIGN SHALL BE MODIFIED TO SUPPORT CONSTRUCTION, MATCH FINAL ELECTRICAL INTERCONNECTION STUDIES, EQUIPMENT PURCHASED, AND POSSIBLE PERMIT CONSTRAINTS REVEALED DURING
- 6. NO SOURCE OF WATER IS AVAILABLE AT THE SITE OR IMMEDIATE AREA TO SUPPORT FIRE
- 7. NO BUILDINGS ARE EXISTING OR PROPOSED...
- 8. THE 1-FOOT TOPOGRAPHY AND PROPERTY BOUNDARY SHOWN ON THESE DRAWINGS WERE PROVIDED TO TRC BY GREENMAN-PEDERSEN, INC. ON JANUARY 19, 2022.
- NET DEVELOPMENT AREA (AREA WITHIN THE FENCE LINE TO BE 1,170,460 SQ.-FT. OR 26.87 AC. AREA UNDER PANELS TO BE 5.46 AC. ACCESS ROAD AREA TO BE 0.71 AC.
- 10. APPLICANT: BROOM SOLAR PARTNERS LLC (EDF RENEWABLES)

6940 COLUMBIA GATEWAY DRIVE, SUITE 400 COLUMBIA, MD 21046 OWNER: WILGUS FAMILY REVOCABLE TRUST ROBERT E. WILGUS, JR.

34108 WILGUS CEMETERY ROAD FRANKFORD, DE 19945

ZONING CONFORMANCE TABLE			
Zoning Code Description	Zoning Code Requirement	Proposed Project	
Zoning Designation	Agricultural Residential -1	Agricultural Residential -	
Minimum Lot Area	10,000 square feet	3,043,621 square feet	
Minimum Lot Width	150 feet	1,383 feet	
Minimum Lot Depth	100 feet	2,127 feet	
Maximum Building Height	42 feet	Not Applicable (Equipment height not more than 12 feet)	
Front Yard Depth	40 feet	799 feet	
Side Yard Depth	10 feet	41 feet	
Rear Yard Depth	10 feet	67 feet	


CONDITION	D MARCH 22, 2022
A. No storage facilities shall be constructed on the site.	No storage facilities are proposed.
B. Lighting on the facility shall only consist of perimeter lighting needed for security purposes. All lighting shall be downward screened so that it does not shine on neighboring properties or roadways.	No lighting is proposed.
C. One unlighted sign, not to exceed 32 square feet in size, shall be permitted.	No sign is proposed.
D. The site shall be secured by fencing with a gate with a "Knox Box" or similar device to accommodate emergency access by the local fire company or other emergency responders. The fence line shall be shown on the Final Site Plan.	See Site Plan for location of "Knox Box" and fence. See "Knox Box" and fence details on Drawing No. C-5.0.
E. Any transformers or similar equipment shall be centrally located on the site away from any nearby residential uses.	See Site Plan for location.
F. All of the grounds, including the area outside of the fence, shall be maintained so that they do not become overgrown.	Project owner to maintain vegetation to approximately 5 feet outside the proposed perimeter fenceline. The remainder of the property is not under the control of the project owner (i.e. outside the leasehold) and will remai in the control of the property owner; most likely toontinue to be farmed.
G. The Final Site Plan shall be subject to the review and	Acknowledged.
approval of the Sussex County Planning and Zoning	

SHEET SIZE: 24" BY 36"

(DRAWING MAY BE PRINTED AT REDUCED SIZE)





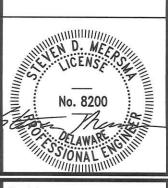

//2	distoris.		
	Date:		
	07/05/2022		

Drawn by: EK, CV, AR

Design by:

Checked by:

Contract No: 376627 Scale: AS NOTED **JUNE 2022** Sheet: SITE PLAN Drawing No: C-4.0



PROJECT	SUMMARY	
ARRAY TYPE	SAT	
ARRAY ORIENTATION (°)	18	30
	PV MODULE 1	PV MODULE 2
PV MODULE MANUFACTURER	CANADIA	N SOLAR
PV MODULE MODEL	CS3W-445-MB-AG	CS3W-400-PB-AG
PV MODULE WATTAGE (W)	445	400
PV MODULE QUANTITY	6,966	2,322
PV MODULES PER STRING	2	7
PV MODULES PER TRACKER / TABLE	54 / 72	
TRACKER / TABLE QUANTITY	168 / 12	
TRACKER PITCH / TABLE ROW SPACING (FT)	48.27	
	INVERTER 1	INVERTER 2
INVERTER MANUFACTURER	CHINT POWE	R SYSTEMS
INVERTER MODEL	SCH125KTL-DO/US-600	
INVERTER RATING (kWAC)	125	
INVERTER QUANTITY	24	
TOTAL PV MODULE CAPACITY (kWDC)	4,028.67	
TOTAL INVERTER CAPACITY (kWAC)	3,000	
AREA WITHIN FENCE (ACRES)	26.87	
LENGTH OF FENCE (FT)	5,0)33
LENGTH OF ACCESS DRIVE (FT)	1,7	'10

LEGEND

SYMBOL	DESCRIPTION
	EXISTING PROPERTY LINE
	APPROXIMATE EXISTING ABUTTER PROPERTY LINE
	PROPOSED PROJECT FENCE
	PROPOSED GRAVEL ACCESS DRIVEWA
MVMV	PROPOSED MEDIUM VOLTAGE CIRCUIT
OE	PROPOSED OVERHEAD LINE
\varnothing	PROPOSED OVERHEAD POLES
55	EXISTING MAJOR CONTOUR (FEET)
54	EXISTING MINOR CONTOUR (FEET)
	TAX DITCH RIGHT-OF-WAY LIMIT
LOD	LIMITS OF DISTURBANCE

ZONING CONFORMANCE TABLE			
Zoning Code Description	Zoning Code Requirement	Proposed Project	
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NOTES


- 1. AREAS OUTSIDE PROPOSED FENCE TO REMAIN AS OPEN SPACE.
- 2. ADJOINING PROPERTY OWNER INFORMATION SHOWN ARE FROM SUSSEX COUNTY GIS PORTAL. (HTTPS://MAPS.SUSSEXCOUNTYDE.GOV/PZAPPLICATIONS/MAP.HTML)
- 3. SITE IS NOT LOCATED IN A 100-YEAR OR 500-YEAR FLOOD PLAIN.
- EXISTING UTILITIES ARE APPROXIMATE AND SHOULD BE VERIFIED BY CONTRACTOR. DIG SAFELY DELAWARE (811) SHALL BE NOTIFIED A MINIMUM OF 72-HOURS PRIOR TO COMMENCING ANY EXCAVATION.
- 5. THIS IS A PRELIMINARY DESIGN PLAN PROVIDED FOR PERMITTING ONLY, FINAL DESIGN SHALL BE MODIFIED TO SUPPORT CONSTRUCTION, MATCH FINAL ELECTRICAL INTERCONNECTION STUDIES, EQUIPMENT PURCHASED, AND POSSIBLE PERMIT CONSTRAINTS REVEALED DURING PROJECT'S REVIEW.
- 6. NO SOURCE OF WATER IS AVAILABLE AT THE SITE OR IMMEDIATE AREA TO SUPPORT FIRE
- 7. NO BUILDINGS ARE EXISTING OR PROPOSED..
- 8. THE 1-FOOT TOPOGRAPHY AND PROPERTY BOUNDARY SHOWN ON THESE DRAWINGS WERE PROVIDED TO TRC BY GREENMAN-PEDERSEN, INC. ON JANUARY 19, 2022.
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- JEFF MACHIRAN 6940 COLUMBIA GATEWAY DRIVE, SUITE 400 COLUMBIA, MD 21046 OWNER: WILGUS FAMILY REVOCABLE TRUST ROBERT E. WILGUS, JR. 34108 WILGUS CEMETERY ROAD FRANKFORD, DE 19945

ISSUED FOR PRELIMINARY SITE PLAN APPROVAL. NOT FOR CONSTRUCTION. SCALE: 1" = 80'

SHEET SIZE: 24" BY 36" (DRAWING MAY BE PRINTED AT REDUCED SIZE)





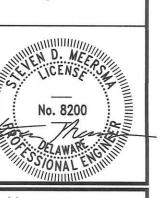


Drawn by: EK, CV, AR Design by:

Checked by:

Contract No: 376627 Scale: AS NOTED JUNE 2022

Sheet: SITE PLAN NORTH Drawing No:

C-4.1

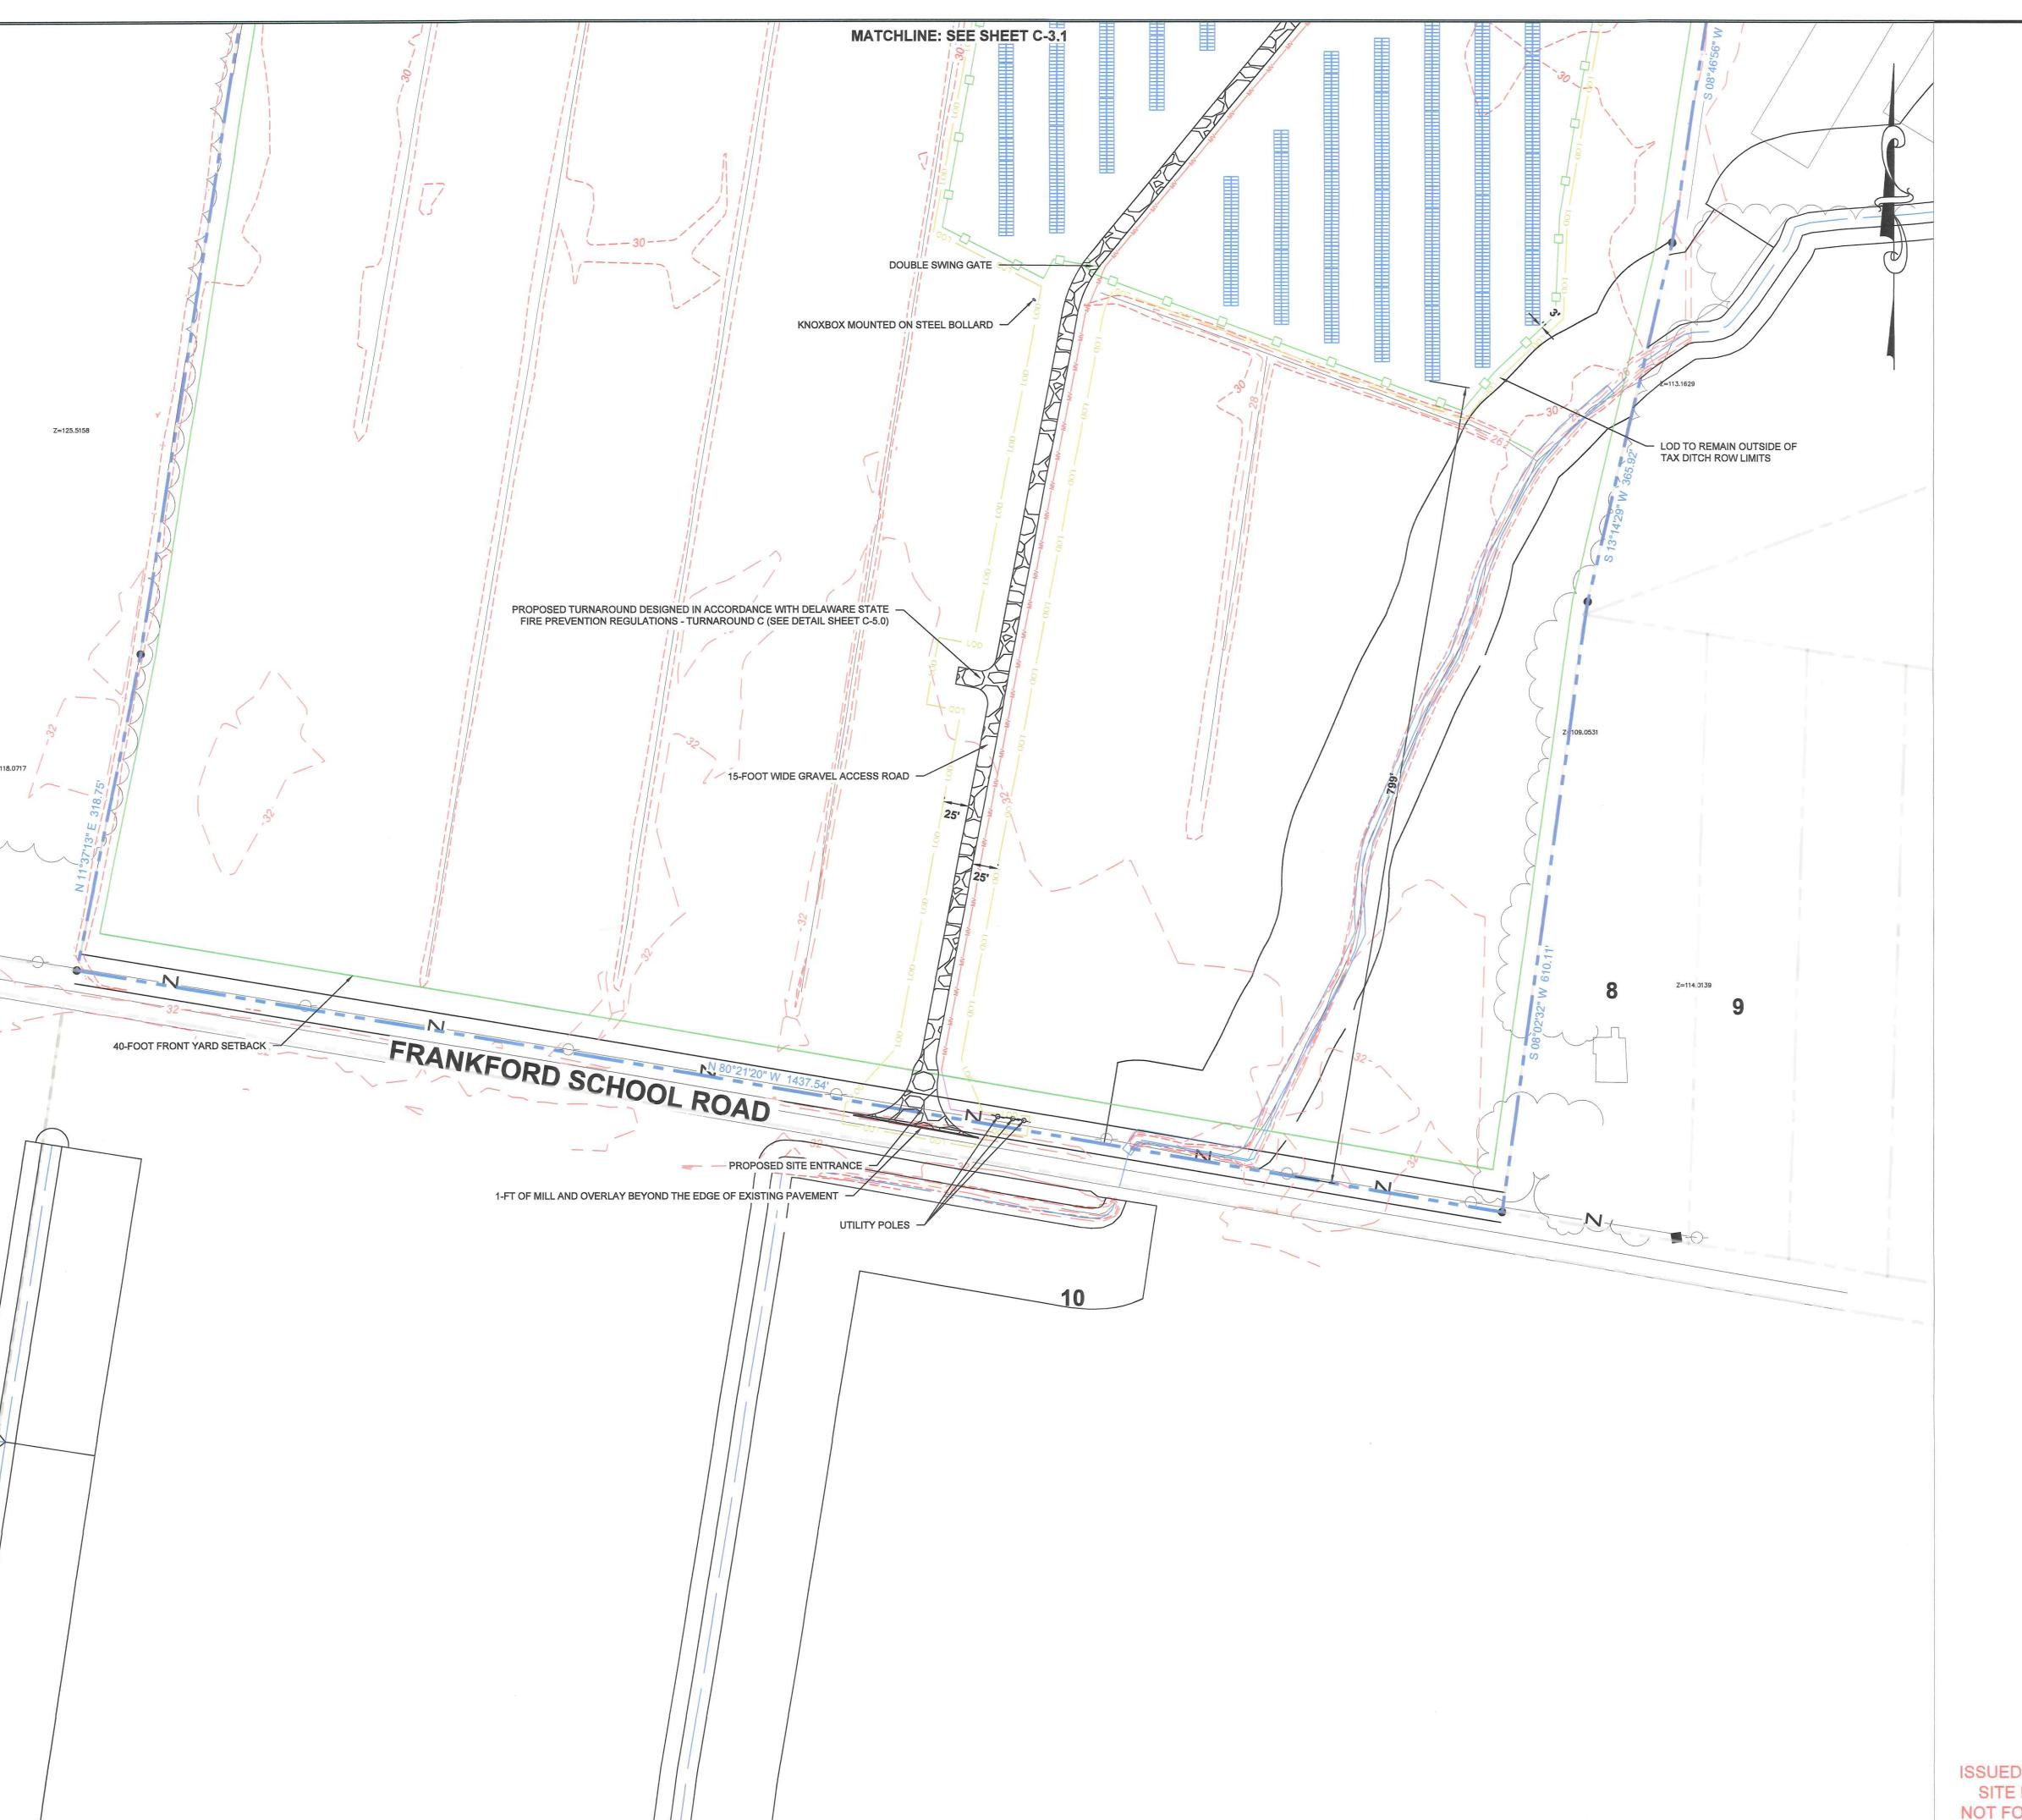

PROJECT	SUMMARY	
ARRAY TYPE	SAT	
ARRAY ORIENTATION (°)	18	30
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PV MODULES PER STRING	2	7
PV MODULES PER TRACKER / TABLE	54 / 72	
TRACKER / TABLE QUANTITY	168 / 12	
TRACKER PITCH / TABLE ROW SPACING (FT)	48	.27
	INVERTER 1	INVERTER 2
INVERTER MANUFACTURER	CHINT POWE	ER SYSTEMS
INVERTER MODEL	SCH125KTL	-DO/US-600
INVERTER RATING (kWAC)	12	25
INVERTER QUANTITY	2	4
TOTAL PV MODULE CAPACITY (kWDC)	4,02	8.67
TOTAL INVERTER CAPACITY (kWAC)	3,000	
AREA WITHIN FENCE (ACRES)	26	.87
LENGTH OF FENCE (FT)	5,0	133
LENGTH OF ACCESS DRIVE (FT)	1,7	10

LEGEND

SYMBOL	DESCRIPTION
	EXISTING PROPERTY LINE
	APPROXIMATE EXISTING ABUTTER PROPERTY LINE
	PROPOSED PROJECT FENCE
	PROPOSED GRAVEL ACCESS DRIVEWAY
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 STUDIES, EQUIPMENT PURCHASED, AND POSSIBLE PERMIT CONSTRAINTS REVEALED DURING
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JEFF MACHIRAN
6940 COLUMBIA GATEWAY DRIVE, SUITE 400
COLUMBIA, MD 21046
OWNER: WILGUS FAMILY REVOCABLE TRUST
ROBERT E. WILGUS, JR.
34108 WILGUS CEMETERY ROAD
FRANKFORD, DE 19945

ISSUED FOR PRELIMINARY SITE PLAN APPROVAL. NOT FOR CONSTRUCTION. SCALE: 1" = 80'


SHEET SIZE: 24" BY 36"
(DRAWING MAY BE PRINTED AT REDUCED SIZE)

1430 Broadway 10th Floor New York, NY 10018 Phone: 212 221 7822



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Drawn by:

Drawn by:
EK, CV, AR

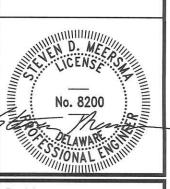Design by:
CG


Checked by:
SM

BROOM SOLAR PARTNERS, LLC
D/B/A INDIAN RIVER SOLAR FARM
SIAN RIVER SOLAR FARM F/K/A BROOM SOLAR
ADJACENT TO 32419 FRANKFORD SCHOOL ROAD

Contract No:
376627
Scale:
AS NOTED
Date:
JUNE 2022
Sheet:

SITE PLAN SOUTH
Drawing No:

C-4.2

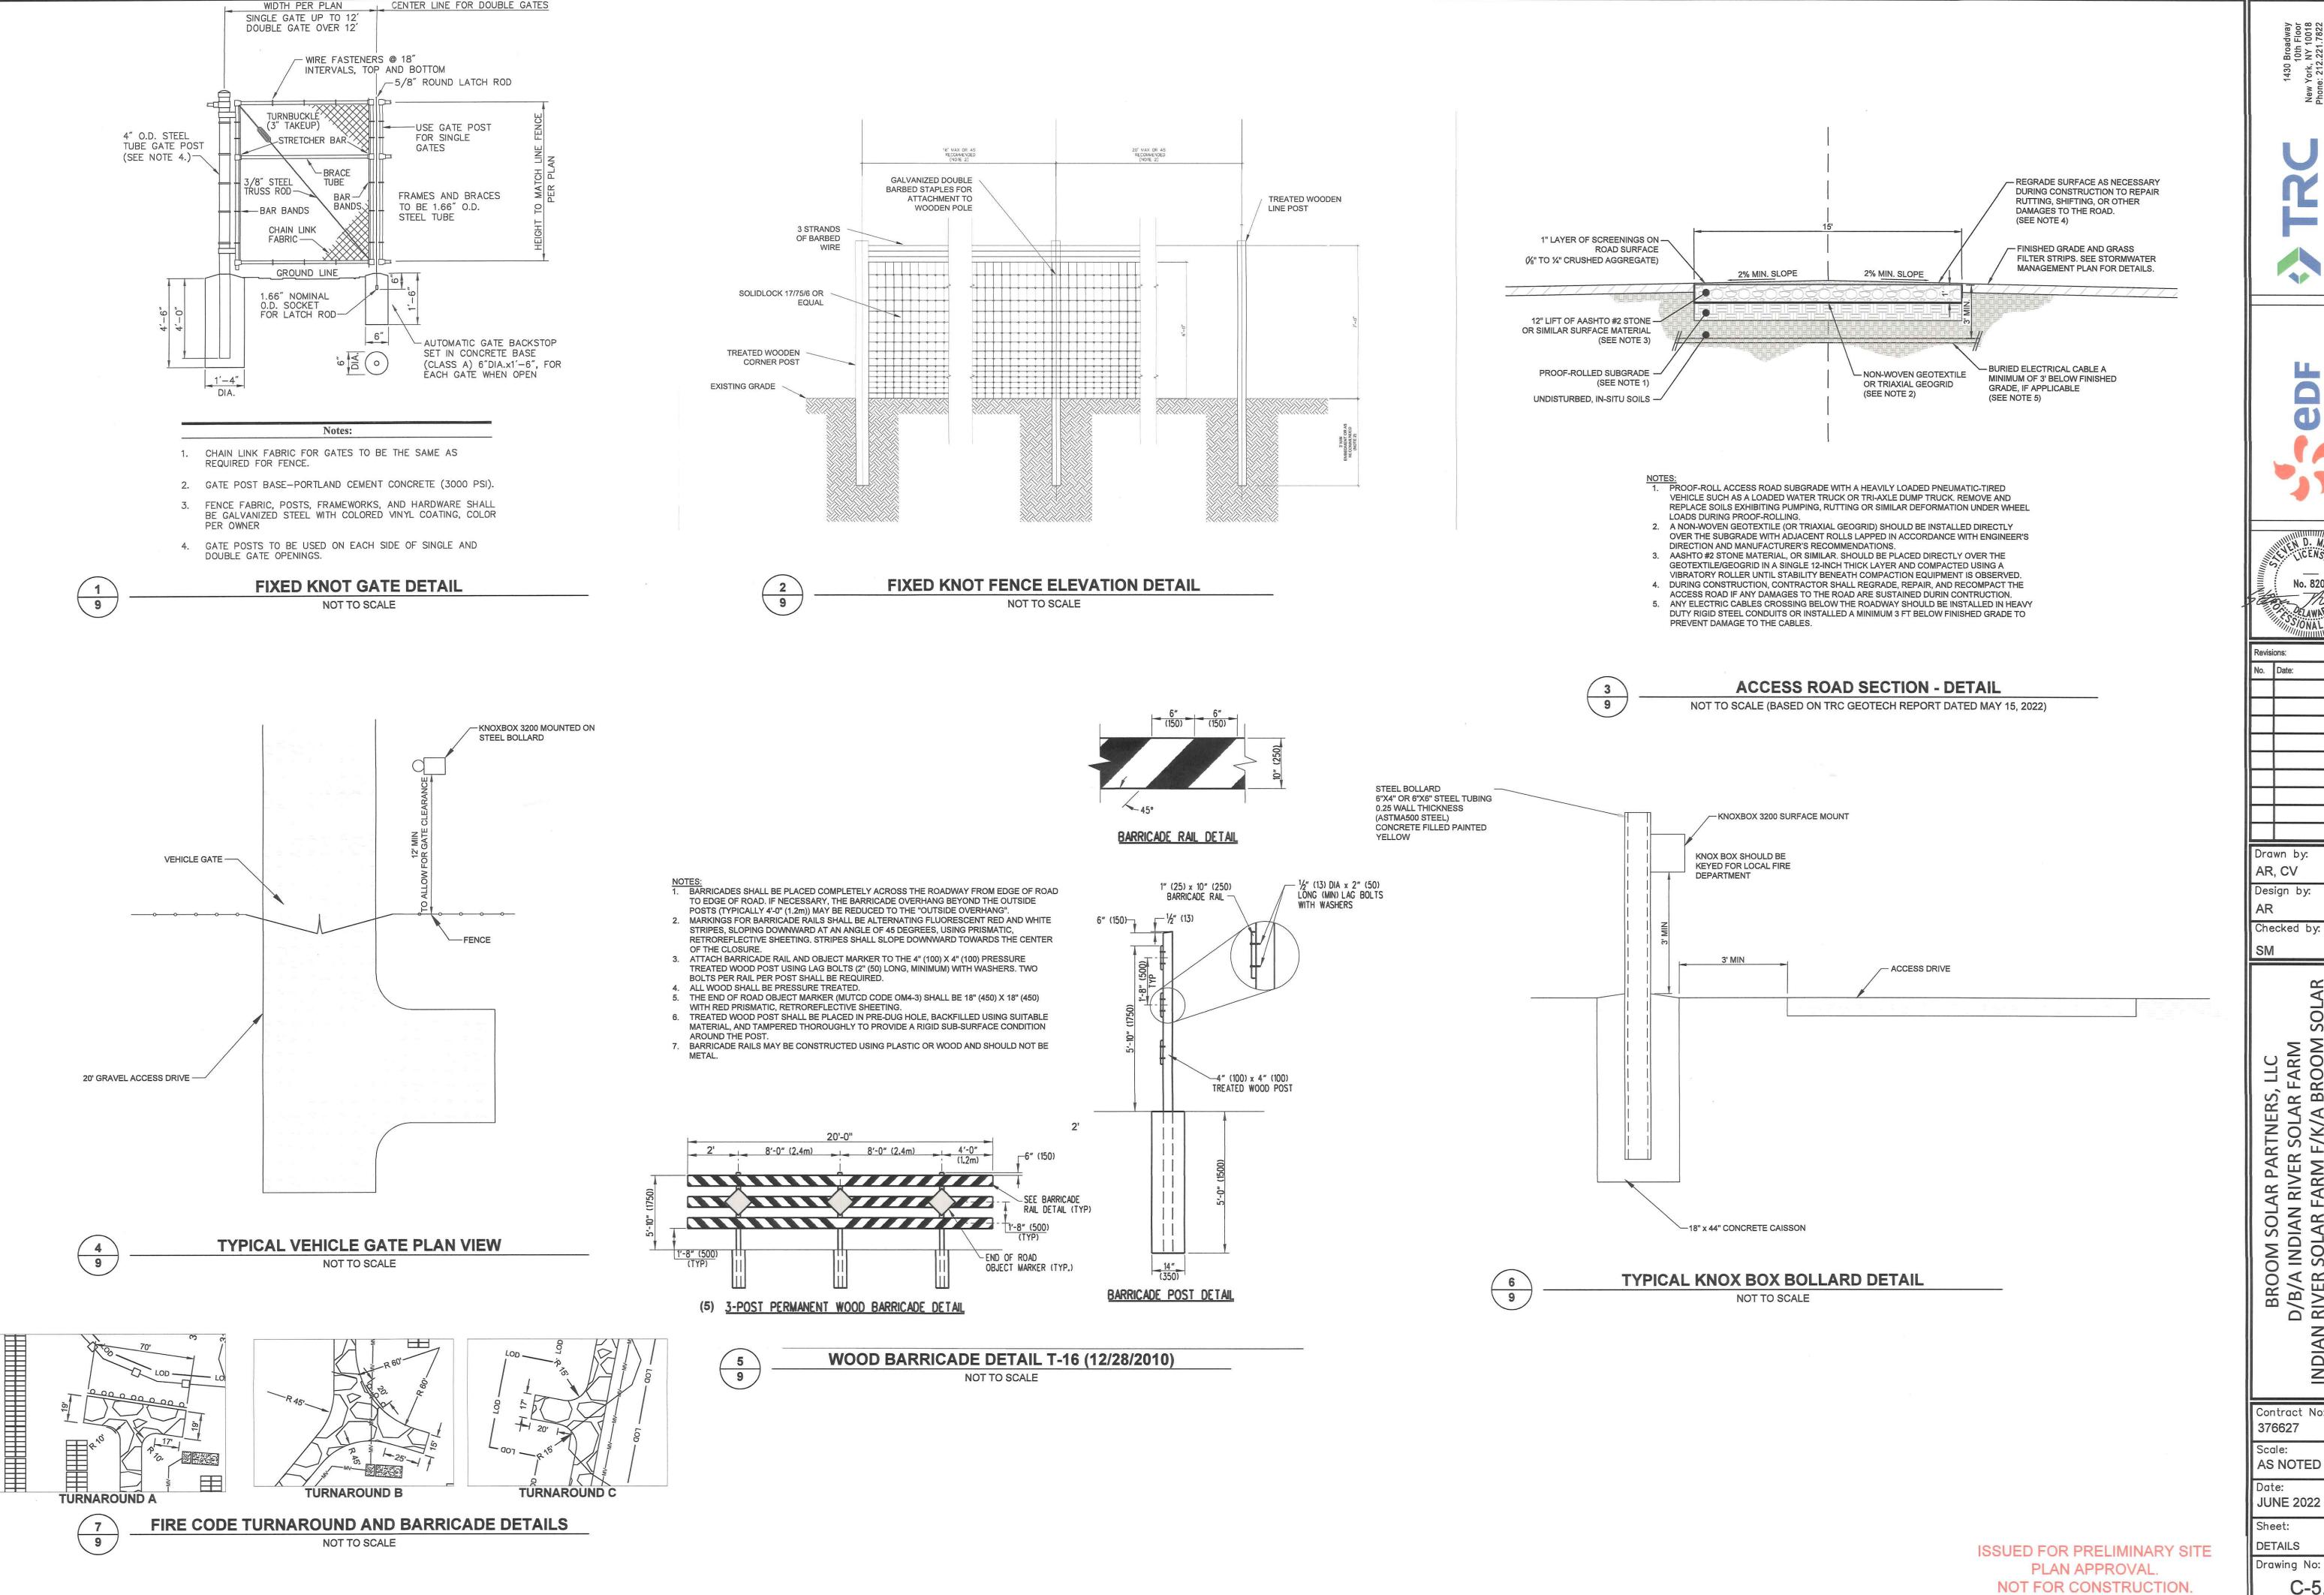

Broadway 10th Floor NY 10018 2.221.7822

U

No. 8200

Drawn by: AR, CV Design by:

Checked by:


INDIAN

Contract No: 376627 Scale:

AS NOTED

DETAILS

Drawing No: C-5.0

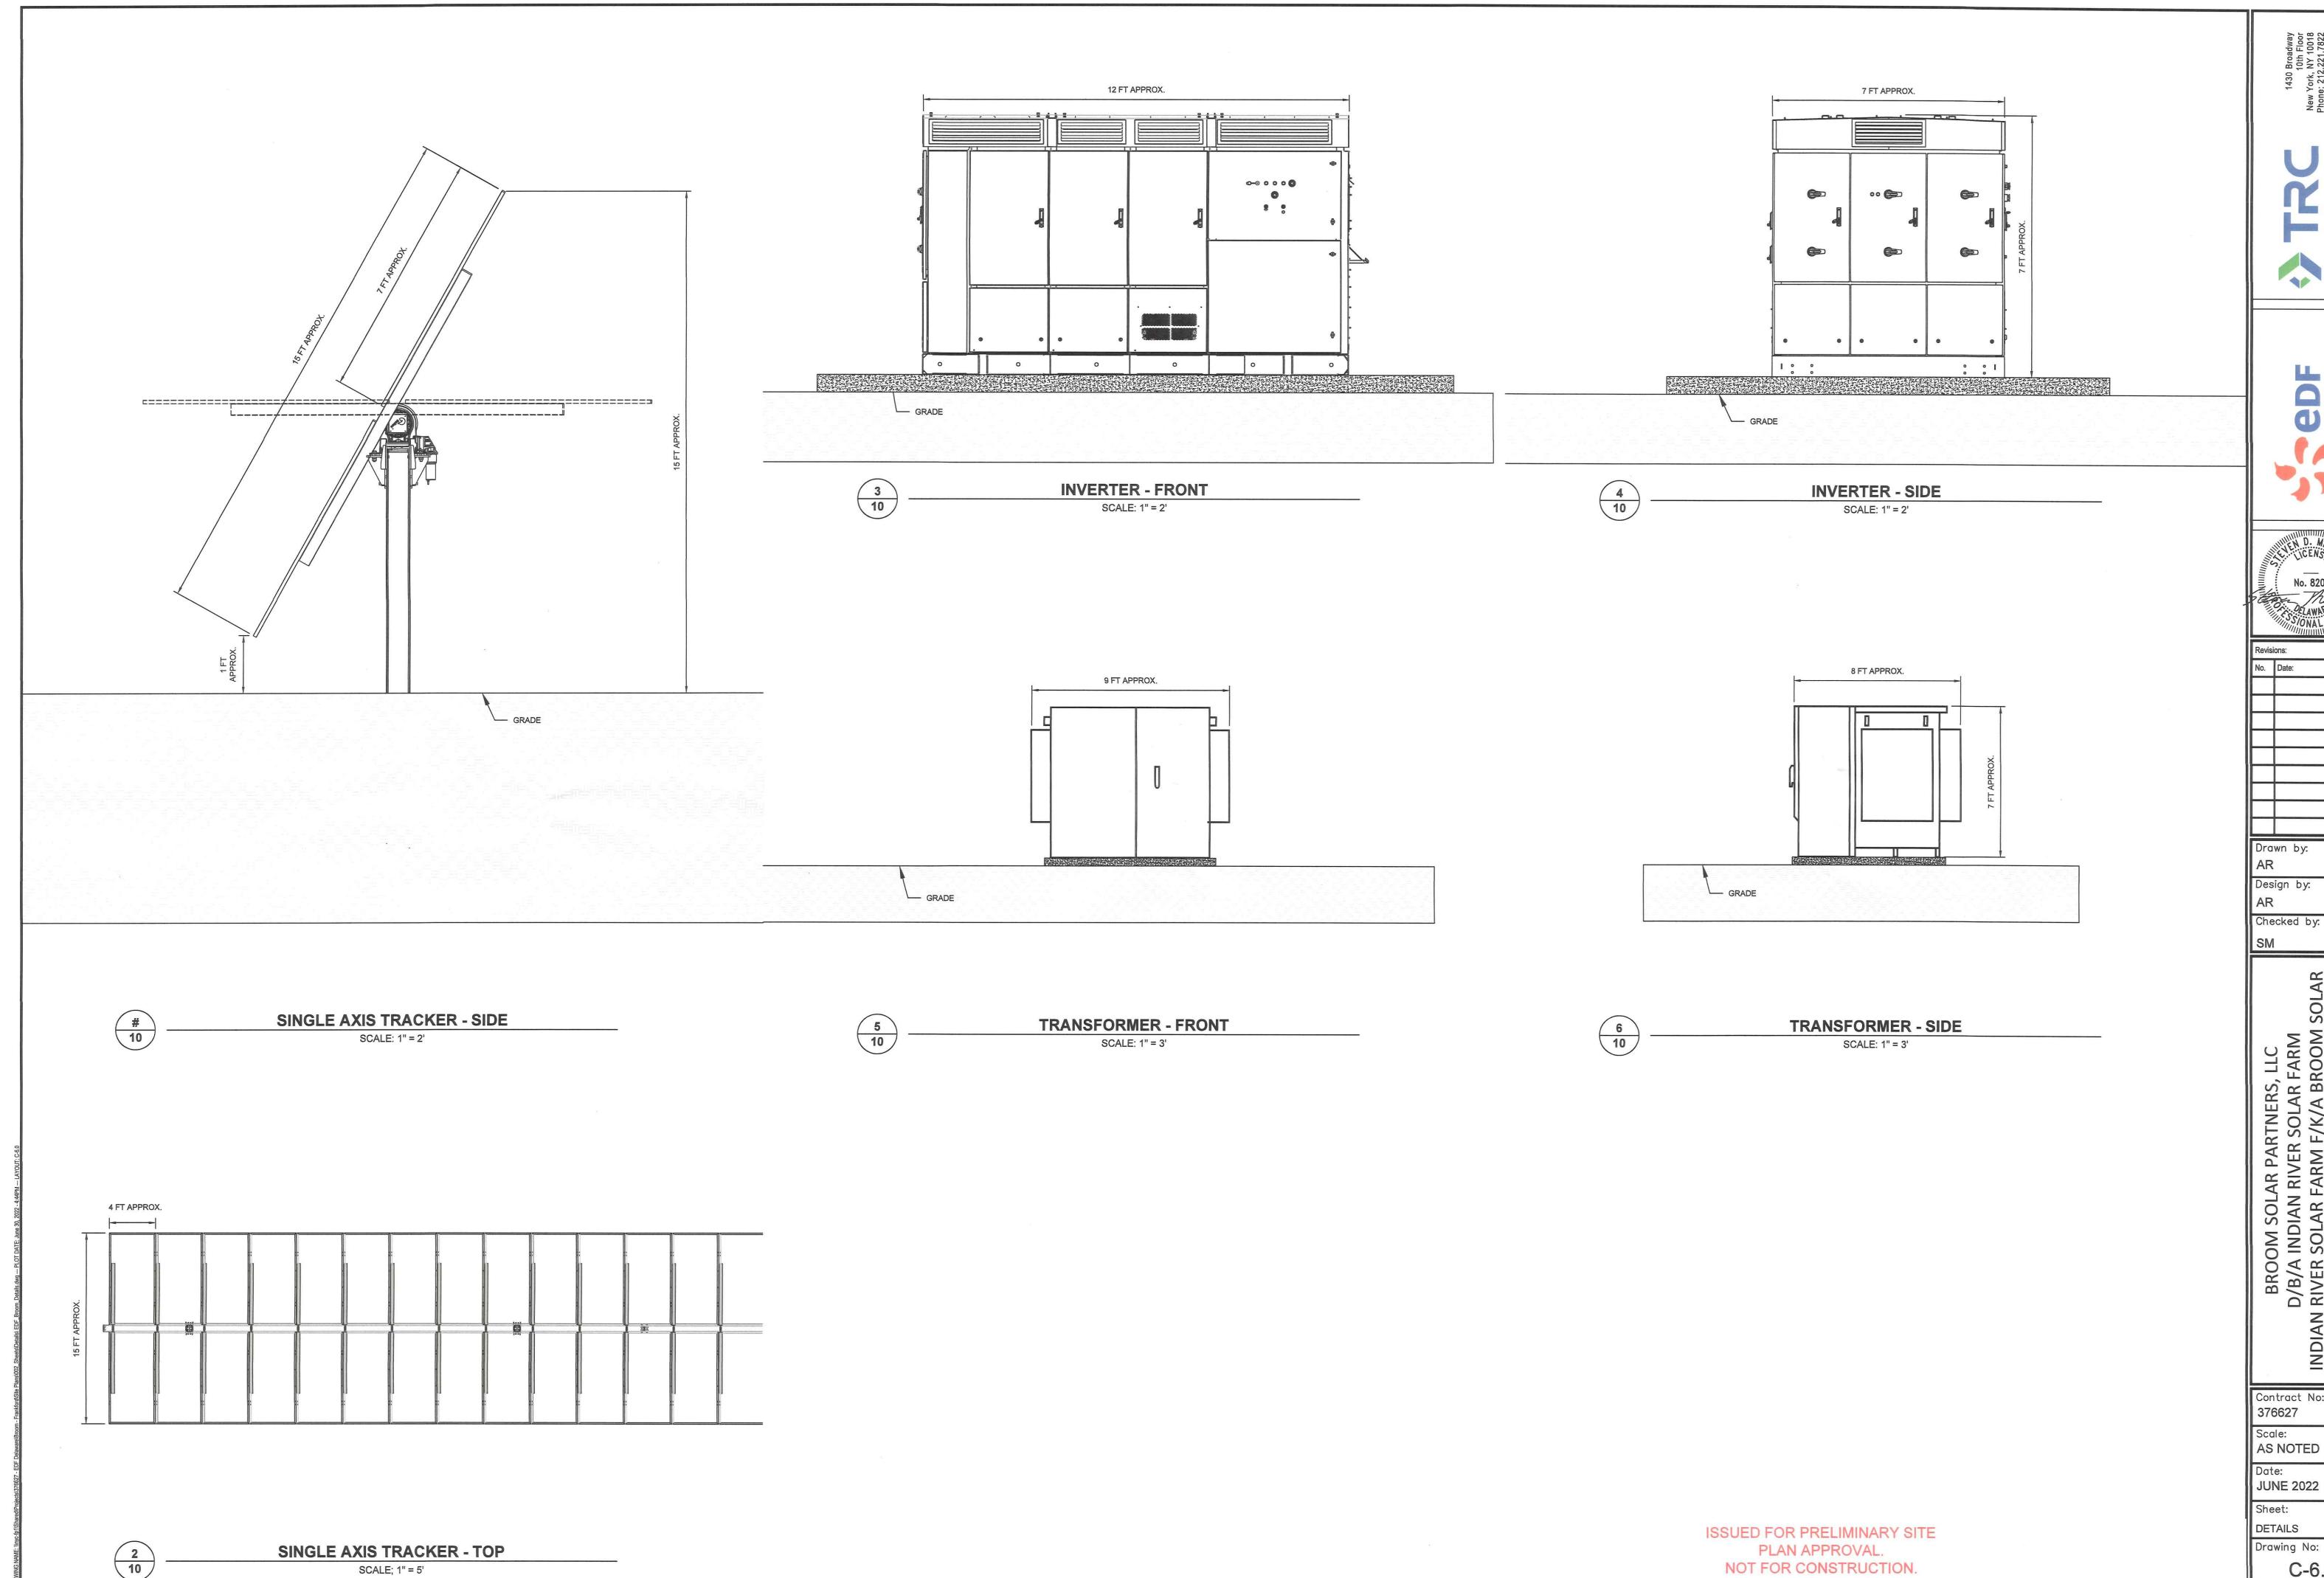

SCALE; 1" = 5'

Design by: Checked by:

BROOM SOLAR PARTNERS, LLC
D/B/A INDIAN RIVER SOLAR FARM
INDIAN RIVER SOLAR FARM F/K/A BROOM SOLAR
ADJACENT TO 32419 FRANKFORD SCHOOL ROAD
FRANKFORD, DELAWARE 19945


Contract No: 376627

AS NOTED

Sheet:


NOT FOR CONSTRUCTION.

Drawing No: C-6.0

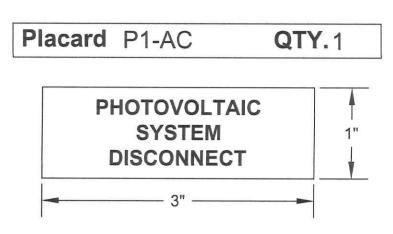


690.14(C)(2) - Additional provisions, requirements for disconnecting means, marking. Each photovoltaic system disconnecting means shall be permanently marked to identify it as a photovoltaic system disconnect.

Apply to Main AC disconnecting means on switchboard.

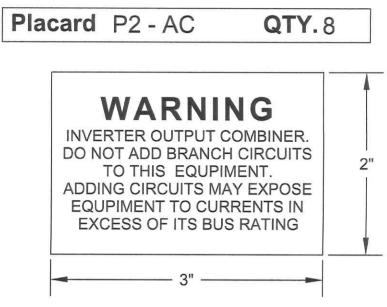


Not specifically required by NEC. Good practice to make clear that inverter output combiner panels are not to be used to supply branch circuits.

Apply to All AC panel boards.

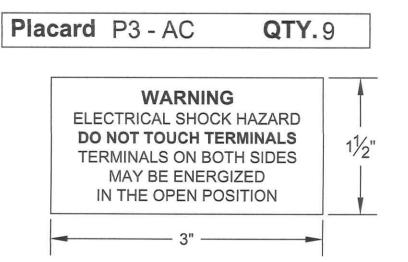


690.17 - Switch or circuit breaker. Where all terminals of the disconnecting means may be energized in the open position, a warning sign shall be mounted on or adjacent to the disconnecting means.

Apply to all AC panel boards and switchboards.

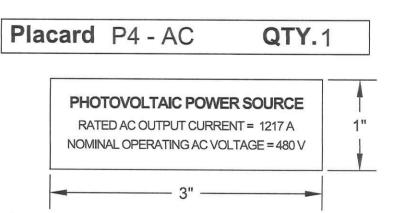

690.54 - Interactive system point of interconnection. All interactive system(s) points of interconnection with other sources shall be marked at an accessible location at the disconnecting means as a power source and with the rated AC output current and the nominal operating AC voltage.


Apply to the main disconnecting means at switchboard.

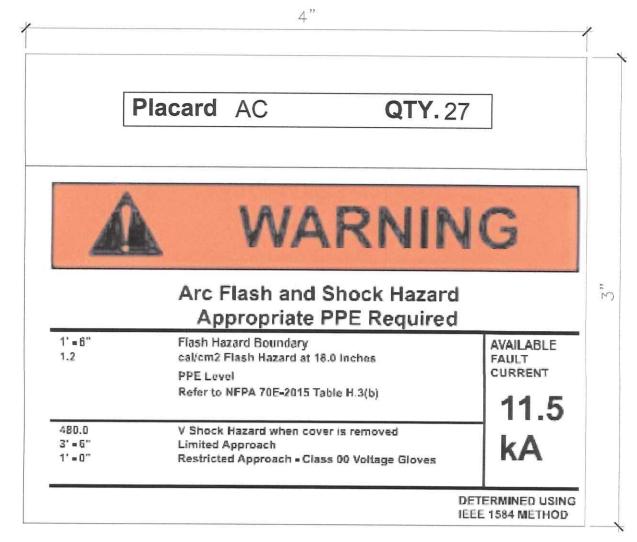

Apply to each inverter, each panel board, the switchboard, and to MPZ load center.

(ABOVE LABEL IS AN EXAMPLE OF ARC FLASH LABELS. THE ACTUAL LABELS WILL BE SPECIFIED AND PROVIDED BY THE EOR)


GROUND FAULT

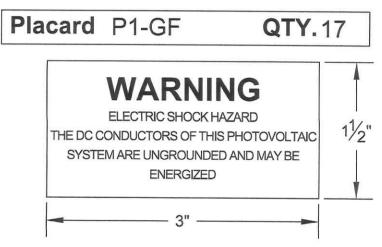


690.5(C) - Ground fault protection, labels and markings. A warning label shall appear on the utility-interactive inverter or be applied by the installer near the ground-fault indicator at a visible location.

Apply to each inverter.


EQUIPMENT LABELS

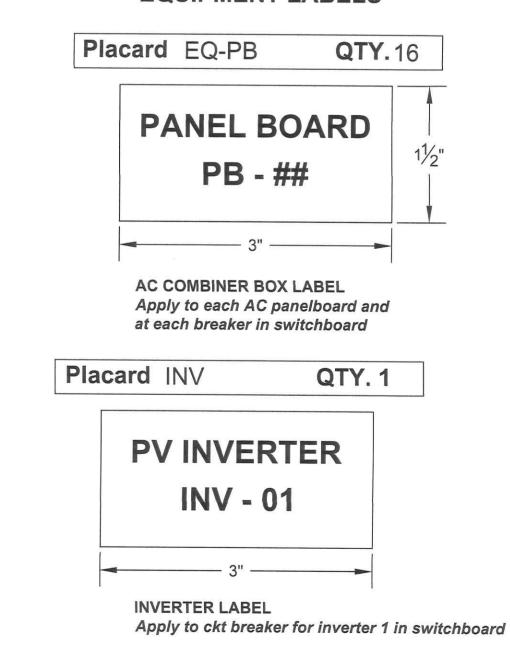

EQUIPMENT LABELS

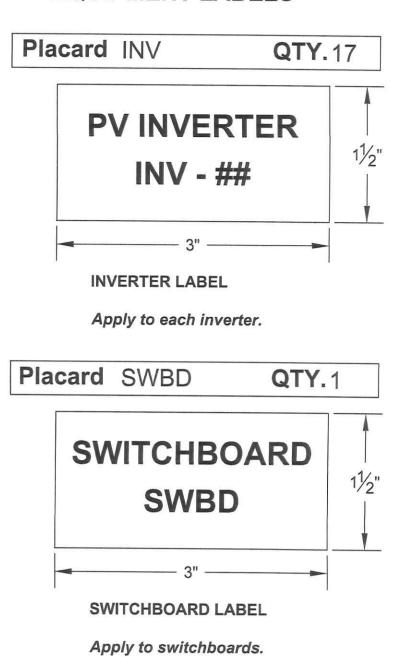

Placard DC LABELS

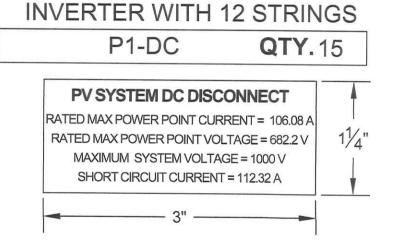

INVERTER WITH 10 STRINGS Placard P1-DC QTY.2 PV SYSTEM DC DISCONNECT RATED MAX POWER POINT CURRENT = 88.4 A RATED MAX POWER POINT VOLTAGE = 682.2 V MAXIMUM SYSTEM VOLTAGE = 1000 V SHORT CIRCUIT CURRENT = 93.6 A

690.53 - Direct current photovoltaic power source. A permanent label for the direct-current photovoltaic power source indicating items (1) through (5) shall be provided by the installer at the photovoltaic

- disconnecting means:
- (1) Rated maximum power point current
- (2) Rated maximum power-point voltage (3) Maximum system voltage
- (4) Short-circuit current
- (5) Maximum rated output current of the charge controller (if installed)


Apply to the inverter DC disconnecting means as indicated in line



MOUNTED GATE AND FENCE LABEL (NOT TO SCALE)

NOTES:

- MOUNT TO EACH GATE DOOR AND FENCE PERIMETER LOCATION (APPROX. EVERY 300') WITH RESPECTIVE NOMENCLATURE.
- 2. THIS SIGN IS TO BE MADE OF ALUMINUM

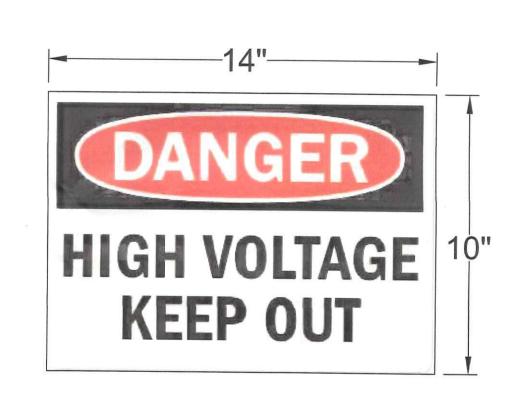

MOUNTED GATE AND FENCE LABEL (NOT TO SCALE)

NOTES:

- MOUNT TO EACH GATE DOOR AND FENCE PERIMETER LOCATION (APPROX. EVERY 50') WITH RESPECTIVE NOMENCLATURE.
- THIS SIGN IS TO BE MADE OF ALUMINUM



SOLAR BROOM SOLAR PARTNERS, LLC
D/B/A INDIAN RIVER SOLAR FARM
N RIVER SOLAR FARM F/K/A BROOM SO
DJACENT TO 32419 FRANKFORD SCHOOL ROAL
FRANKFORD, DELAWARE 19945

eDF

D. MESAS

No. 8200

Drawn by:

Design by:

Checked by:

Contract No: 376627 Scale: **AS NOTED** JUNE 2022 Sheet: DETAILS Drawing No:

C-7.0

ISSUED FOR PRELIMINARY SITE PLAN APPROVAL NOT FOR CONSTRUCTION.

LEGEND

EXISTING R/W LINE EXISTING SETBACK LINE EXISTING WOODS LINE EXISTING EASEMENT LINE EXISTING 5' CONTOUR EXISTING I' CONTOUR


EXISTING EDGE OF PAVEMENT

PROPOSED CHAIN LINK FENCE

PROPOSED EDGE OF GRAVEL

UNDERGROUND TELEPHONE LINE PROPOSED LIMITS OF DISTURBANCE PROPOSED LIMITS OF WORKSPACE _____ SF_____ SF____ PROPOSED SILT FENCE PROPOSED COMPOST FILTER LOG

> EXISTING SOILS LINE PROPOSED STABILIZED CONSTRUCTION FNTRANCE

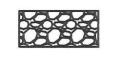

PROPOSED GRAVEL



BROOM SOLAR PROJECT

BROOM SOLAR PARTNERS, LLC SEDIMENT & STORMWATER COVER SHEET

SUSSEX COUNTY, DELAWARE **BALTIMORE HUNDRED** INDIAN RIVER WATERSHED PARCEL 533-5.00-47.00

N/F - PARKER FAMILY

LIMITED PARTNERSHIP PARCEL #533-5.00-85.00 BOOK #3196 PAGE #283

SITE DATA

ADJACENT TO 32419 FRANKFORD SCHOOL ROAD SITE ADDRESS:

FRANKFORD, DE 19945

WILGUS FAMILY REVOCABLE TRUST, ROBERT E. WILGUS JR., AND 2) OWNER:

ELAINE S. WILGUS

34108 WILGUS CEMETERY ROAD FRANKFORD DE, 19945

EDF RENEWABLES DISTRIBUTED SOLUTIONS, INC.

6940 COLUMBIA GATEWAY DR., SUITE 400

COLUMBIA, MD 21046 4) TAX PARCEL: 533-5.00-47.00

4459/108 5) DEED OF RECORD:

AGRICULTURAL RESIDENTIAL (AR-I) 6) ZONING: 71.378 AC. 7) PARCEL AREA:

3.13 AC. 8) LIMIT OF DISTURBANCE: 26.14 AC.

TOPOGRAPHIC 10) DATE OF SURVEY:

GREENMAN-PEDERSEN, INC., 2021

NAD '83 HORIZONTAL II) DATUM: NAVD '88 VERTICAL:

12) PROJECT BENCHMARK:

q) LIMIT OF WORKSPACE:


3) DEVELOPER

ELEV: 32.23' BMI = N: 182,841.61 E: 723,198.87 ELEV: 28.421 DESC: IRON PIPE BM2 = N: 185,010.93


13) AREA WIN 100 YEAR FLOODPLAIN: O AC.

14) PROPOSED IMPERVIOUS:

ACCORDING TO THE "WETLAND AND WATERCOURSE DELINEATION REPORT," PREPARED BY TRC AND DATED MAY 2021 NO JURISDICTIONAL WETLANDS WERE DELINEATED WITHIN THE LIMITS OF DISTURBANCE FOR THIS PROJECT.

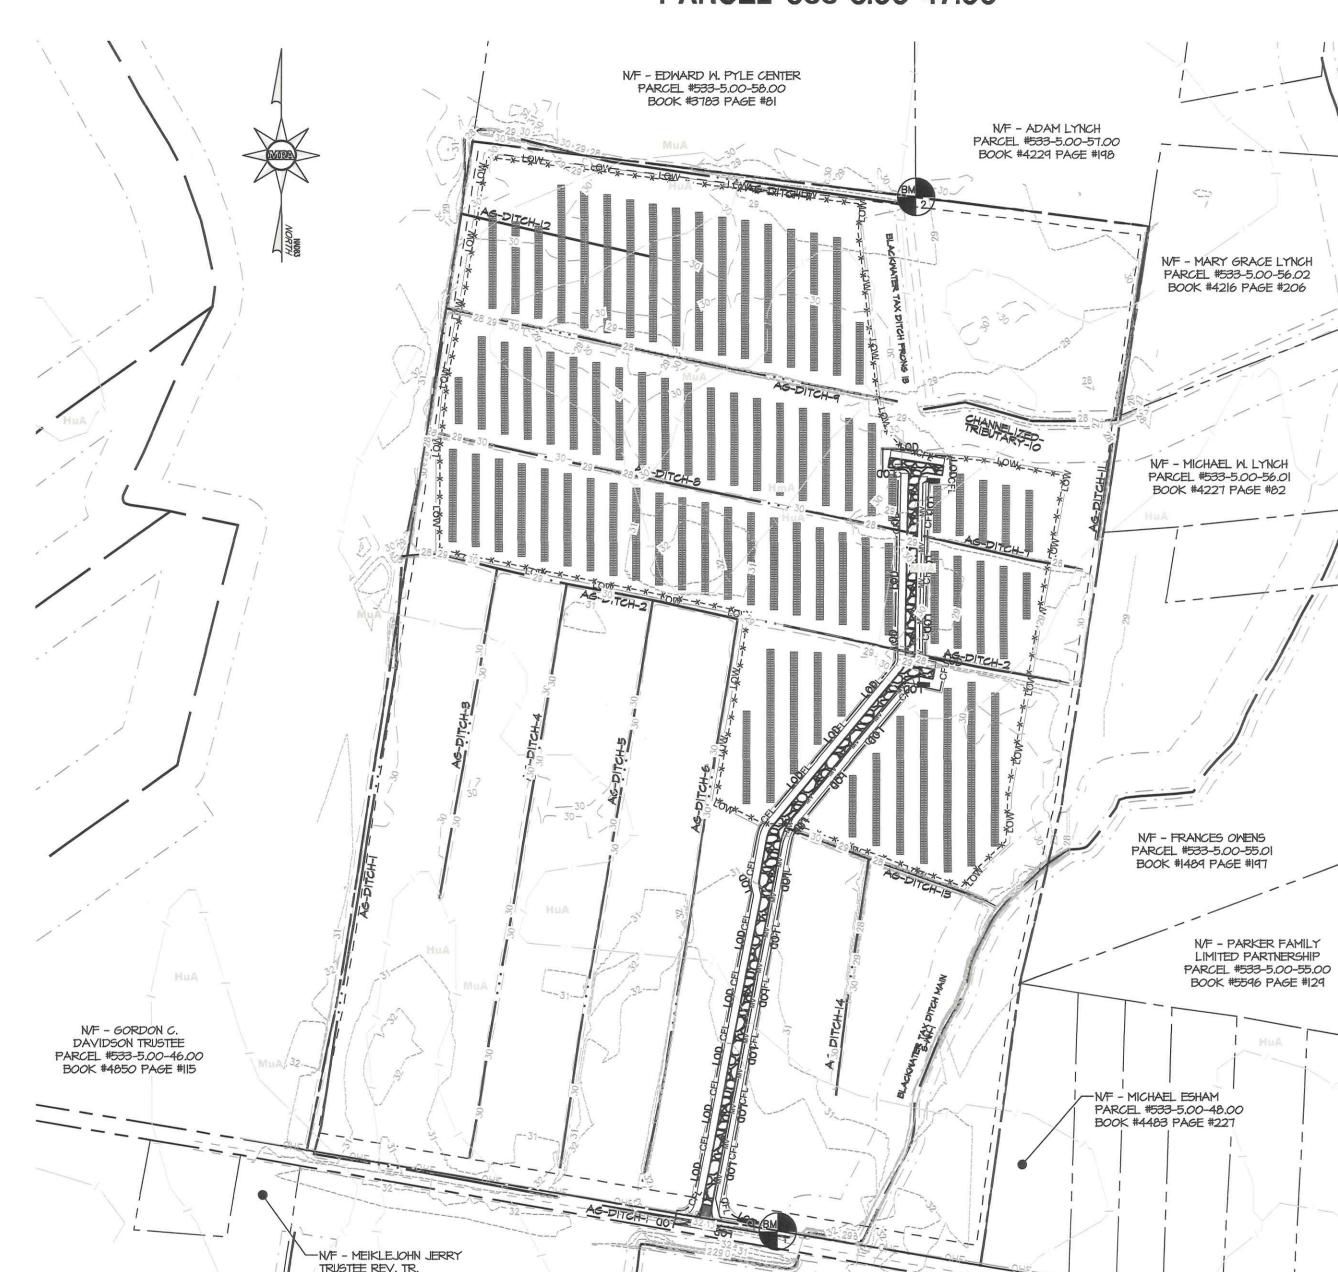

PARCEL #533-5.00-86.00 BOOK #5446 PAGE #235

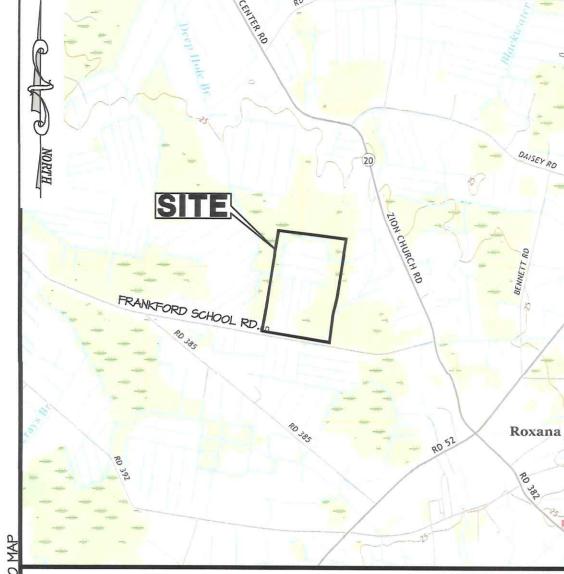

VICINITY MAP SCALE: |" = 2,000 FT MAP GRID NO. 2019112

INDEX OF DRAWINGS

SEDIMENT & STORMWATER COVER SHEET CONSTRUCTION SITE STORMWATER MANAGEMENT PLAN CONSTRUCTION SITE STORMWATER MANAGEMENT DETAILS & NOTES CONSTRUCTION SITE STORMWATER MANAGEMENT DETAILS & NOTES POST CONSTRUCTION STORMWATER MANAGEMENT PLAN

POST CONSTRUCTION STORMWATER MANAGEMENT DETAILS

23818 SHORTLY ROAD GEORGETOWN, DE, 19947 302-856-2105

CERTIFICATION OF PLAN ACCURACY I HEREBY CERTIFY THAT THIS PLAN HAS BEEN PREPARED UNDER MY SUPERVISION AND TO THE BEST OF MY KNOWLEDGE COMPLIES WITH THE APPLICABLE STATE AND LOCAL

PHILLIP L. TOLLIVER, P.E. DE LICENSE NO. #12489 MORRIS & RITCHIE ASSOCIATES, INC. 18 BOULDEN CIRCLE, SUITE 36

NEW CASTLE, DELAWARE 19720

(302) 326-2200 CERTIFICATION OF OWNERSHIP I, MYLES BURNSED, CERTIFY THAT ALL LAND CLEARING, CONSTRUCTION AND DEVELOPMENT SHOULD BE DONE PURSUANT TO THE APPROVED PLAN AND THAT RESPONSIBLE PERSONNEL (I.E. BLUE CARD HOLDER) INVOLVED IN THE LAND DISTURBANCE WILL HAVE A CERTIFICATION OF TRAINING PRIOR TO INITIATION OF THE PROJECT, AT A DNREC SPONSORED OR APPROVED TRAINING COURSE FOR THE CONTROL OF EROSION AND SEDIMENT AT A DINIEC SPONSORED OR APPROVED TRAINING COURSE FOR THE CONTROL OF EROSION AND SEDIMENT DURING CONSTRUCTION. IN ADDITION, I GRANT THE DINREC SEDIMENT AND STORMWATER PROGRAM AND/OR THE RELEVANT DELEGATED AGENCY THE RIGHT TO CONDUIT ONSITE REVIEWS, AND I UNDERSTAND MY


06/16/2022

6/6/2022 Myles Burnsed Myles Burnsed MR. MYLES BURNSED, VICE PRESIDENT OF THE MANAGER EDF RENEWABLES DISTRIBUTED SOLUTIONS, INC P: (215) 609-8240 E: mvles.burnsed@edf—re.com 6940 COLUMBIA GATEWAY DRIVE, SUITE 400

Article XXVIII Administration and Enforcement § 115-221 Final site plan requirements. B.(14)

Wetland and Watercourse Certification

I, Weston Hillegas, certify that the wetland and watercourse delineation is accurate to the best of my knowledge as documented in the 2021 Wetland and Watercourse Delineation Report. A site visit was subsequently conducted with the USACE and DNREC present to confirm wetland and watercourse boundaries on 08/16/2021. A "No Permit Required" (CENAP-OPR-2021-00687-85 Broom Solar SX (NPR)) was issued by the USACE Philadelphia District on February 16, 2022, confirming the proposed project does not involve work or structures in navigable waters, nor does the project involve discharge or fill material into waters of the United States, including wetlands. The Delaware Department of Natural Resources and Environmental Control concurred with USACE in a letter dated February 21, 2022 (JD-236/21). The February 21st letter explains the project will not affect features that are subject to the Subaqueous Lands Act, 7 DEL.C. Chapter 72 or the "Regulations Governing the Use of Subaqueous Lands".

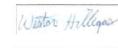

Signature

03/10/2022 Date

Contract No: 376627 Scale:

> AS SHOWN Date:

Drawn by:

Design by:

Checked by:

SHEET C

BROOM SOLAR PARTNERS, LLC
BROOM SOLAR PROJECT
CENT TO 32419 FRANKFORD SCHOOL

CWB

CWB

Sheet: **COVER SHEET**

05/31/2022

Drawing No: 1 OF 6



THE SUSSEX CONSERVATION DISTRICT MUST BE NOTIFIED IN WRITING FIVE (5) DAYS PRIOR TO COMMENCING WITH CONSTRUCTION TO SCHEDULE A PRE-CONSTRUCTION MEETING. FAILURE TO DO SO CONSTITUTES A VIOLATION OF THE APPROVED SEDIMENT AND STORMWATER MANAGEMENT PLAN. REVIEW AND APPROVAL OF THE SEDIMENT AND STORMWATER MANAGEMENT PLAN SHALL NOT RELIEVE THE CONTRACTOR FROM HIS OR HER RESPONSIBILITIES FOR COMPLIANCE WITH THE REQUIREMENTS OF THE SEDIMENT AND STORMWATER REGULATIONS, NOR SHALL IT RELIEVE THE CONTRACTOR FROM ERRORS OR OMISSIONS IN THE APPROVED PLAN. THE APPROVED PLAN NEEDS TO BE MODIFIED, ADDITIONAL SEDIMENT AND STORMWATER CONTROL MEASURES MAY BE REQUIRED AS DEEMED NECESSARY BY THE SUSSEX CONSERVATION DISTRICT.
THE SUSSEX CONSERVATION DISTRICT RESERVES THE RIGHT TO ENTER PRIVATE PROPERTY FOR PURPOSES OF PERIODIC SITE INSPECTION.
FOLLOWING SOIL DISTURBANCE OR REDISTURBANCE-, PERMANENT OR TEMPORARY STABILIZATION SHALL BE COMPLETED WITHIN 14 CALENDAR DAYS AS TO THE SURFACE OF ALL PERIMETER SEDIMENT CONTROLS, TOPSOIL STOCKPILES, AND ALL OTHER DISTURBED OR GRADED AREAS ON THE PROPOSED SITE.
ALL EROSION AND SEDIMENT CONTROL PRACTICES SHALL COMPLY WITH THE DELAWARE EROSION AND SEDIMENT CONTROL HANDBOOK, LATEST EDITION.
AT ANY TIME A DEWATERING OPERATION IS USED, IT SHALL BE PREVIOUSLY APPROVED BY THE AGENCY CONSTRUCTION SITE REVIEWER FOR A NON-EROSIVE POINT OF DISCHARGE, AND A DEWATERING PERMIT SHOULD BE APPROVED BY THE DNREC WELL PERMITTING BRANCH.
THE CONTRACTOR WILL BE RESPONSIBLE TO MAINTAIN AND REPAIR ALL EROSION AND SEDIMENT CONTROL AND STORMWATER MANAGEMENT PRACTICES DURING UTILITY INSTALL ATION.

DNREC AND SUSSEX CONSERVATION DISTRICT (SCD) PERSONNEL SHALL HAVE THE RIGHT TO CONDUCT ON-SITE INSPECTIONS OF LAND DISTURBING ACTIVITIES.
APPROVED PLANS REMAIN VALID FOR 5 YEARS FROM THE DATE OF APPROVAL.
POST CONSTRUCTION VERIFICATION DOCUMENTS SHALL BE SUBMITTED TO THE DEPARTMENT OR DELEGATED AGENCY WITHIN 60-DAYS OF STORMWATER

APPROVED PLANS REMAIN VALID FOR 5 TEAKS FROM THE DATE OF APPROVED.

POST CONSTRUCTION VERIFICATION DOCUMENTS SHALL BE SUBMITTED TO THE DEPARTMENT OR DELEGATED AGENCY WITHIN 60-DAYS OF STORMWATER MANAGEMENT FACILITY COMPLETION.

APPROVAL OF A SEDIMENT AND STORMWATER PLAN DOES NOT GRANT OR IMPLY A RIGHT TO DISCHARGE STORMWATER RUNOFF. THE OWNER/DEVELOPER IS RESPONSIBLE FOR ACQUIRING ANY AND ALL AGREEMENTS, EASEMENTS, ETC., NECESSARY TO COMPLY WITH STATE DRAINAGE AND OTHER APPLICABLE LAWS.

THE CONTRACTOR SHALL USE A STREET SWEEPER AS REQUIRED TO MINIMIZE DUST AND SOIL ON ROADWAYS. IF DUST BECOMES A PROBLEM, THE CONTRACTOR SHALL APPLY WATER TO THE CONSTRUCTION RIGHT-OF-WAY TO PROVIDE DUST CONTROL.

THE NOTICE OF INTENT FOR STORM WATER DISCHARGES ASSOCIATED WITH CONSTRUCTION ACTIVITY UNDER A NPDES GENERAL PERMIT FOR THIS PROJECT IS ***NOW*. THE PERMITTED OF RECORD SHALL NOT BE RELIEVED OF THEIR RESPONSIBILITIES UNTIL A NOTICE OF TERMINATION HAS BEEN PROCESSED BY DNREC. THE OWNER SHALL BE FAMILIAR WITH AND COMPLY WITH ALL ASPECTS OF THE NPDES CONSTRUCTION GENERAL PERMIT ASSOCIATED WITH THE PROJECT.

THE OWNER SHALL BE FAMILIAR WITH AND COMPLY WITH ALL ASPECTS OF THE NPDES CONSTRUCTION GENERAL PERMIT ASSOCIATED WITH THE PROJECT.


THE CONTRACTOR SHALL AT ALL TIMES PROTECT AGAINST SEDIMENT OR DEBRIS LADEN RUNOFF OR WIND FROM LEAVING THE SITE. PERIMETER CONTROLS SHALL BE REMOVED WHEN IT HAS REACHED HALF OF THE EFFECTIVE CAPACITY OF THE CONTROL. SEDIMENT FROM LEAVING THE SITE. ACCUMILATED SEDIMENT SHALL BE REMOVED WHEN IT HAS REACHED HALF OF THE EFFECTIVE CAPACITY OF THE CONTROL. IN ADDITION, THE HAVE ALL THAT THE PROVIDED TO HELD PROVIDED BY THE AGENCY CONSTRUCTION SITE REVIEWER.


ALTER MEASURES IN TIMES OF ADVERSE WEATHER CONDITIONS, OR AS DIRECTED BY THE AGENCY CONSTRUCTION SITE REVIEWER.

ALTER MEASURES IN TIMES OF ADVERSE WEATHER CONDITIONS, OR AS DIRECTED BY THE AGENCY CONSTRUCTION SITE REVIEWER.

ALTER MEASURES IN TIMES OF ADVERSE WEATHER CONDITIONS, OR AS DIRECTED BY THE AGENCY CONSTRUCTION SITE REVIEWER.

ACCORD

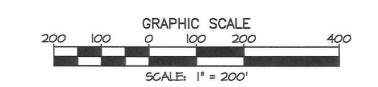

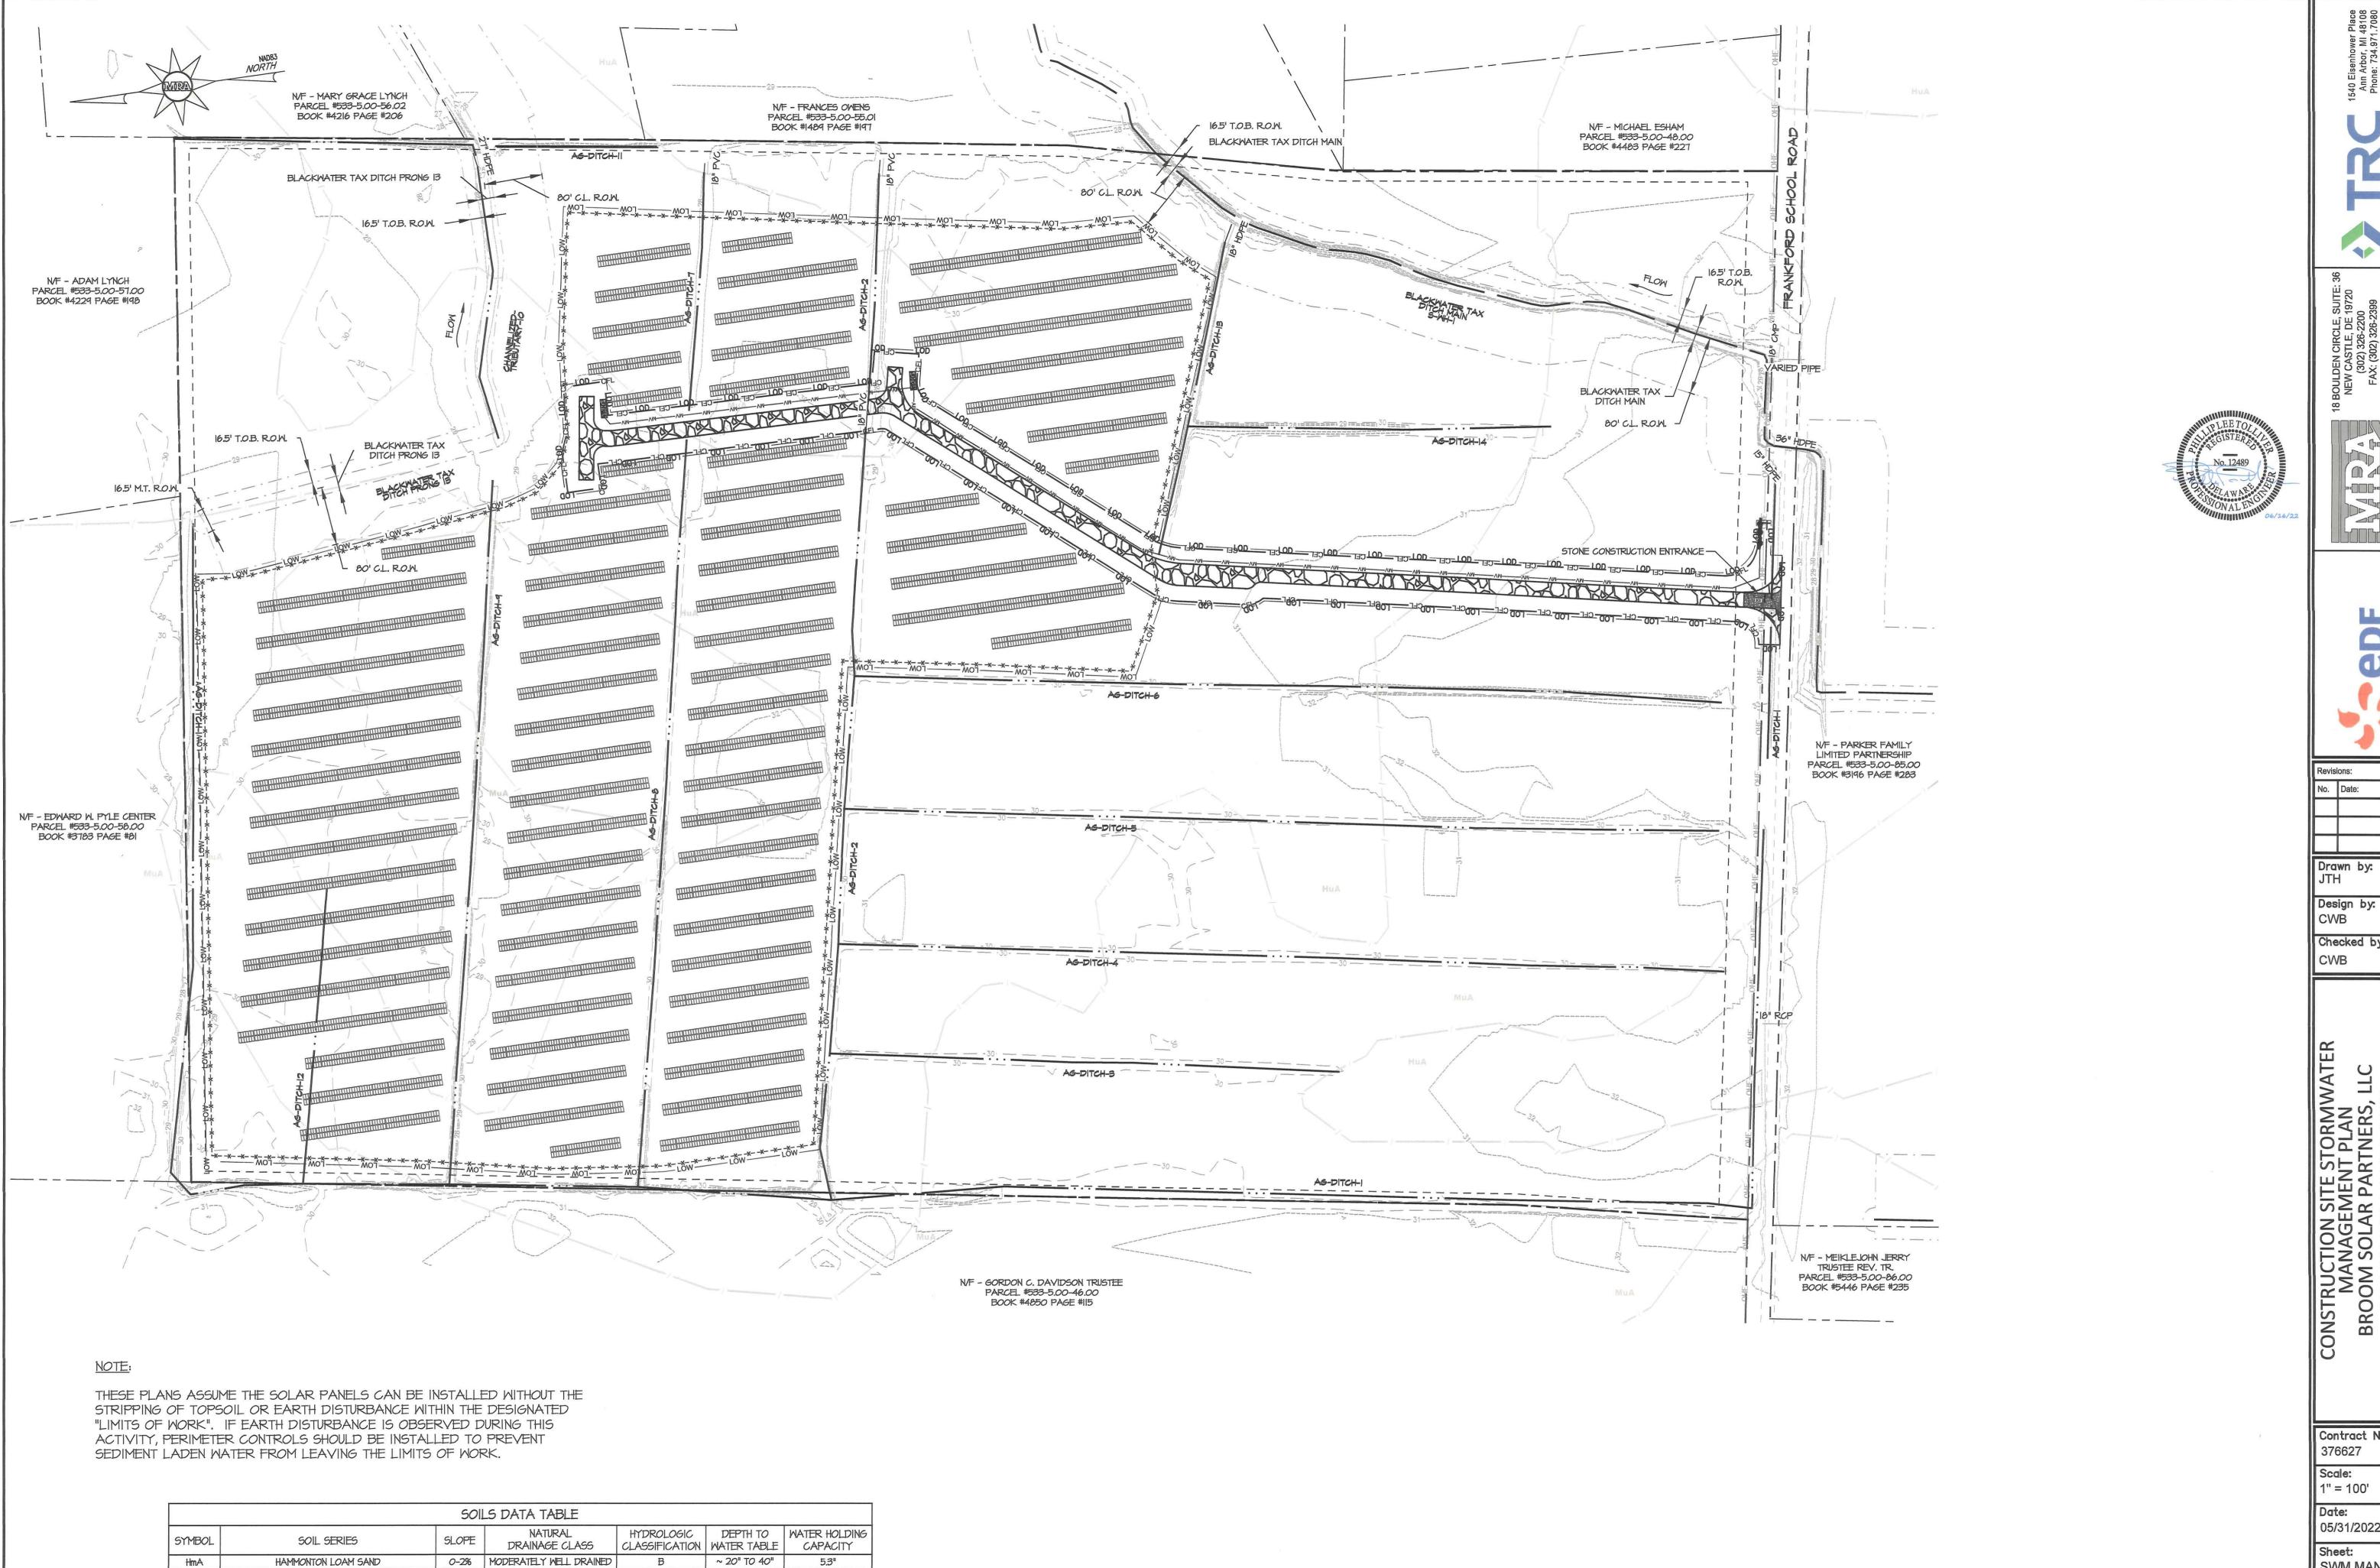

~ 20" TO 40"

~ 10" TO 20"

~ 0" TO 10"

POORLY DRAINED

0-2% VERY POORLY DRAINED

5.3"

6.4"

HAMMONTON LOAM SAND

HURLOCK LOAMY SAND

MULLICA-BERRYLAND COMPLEX

HmA

HUA

wer MI 97

Drawn by:

Checked by:

Contract No:

05/31/2022 Sheet:

SWM MAN.PLAN Drawing No: 2 OF 6

SCALE: |" = 100"

Effective February 2019



- d. Trash shall be disposed of in accordance with all applicable Delaware laws.
- e. Trash cans shall be placed at all lunch spots and littering is strictly prohibited. Recycle bins shall be placed near the construction trailer.
- f. If fertilizer bags can not be stored in a weather-proof location, they shall be kept on a pallet and covered with plastic sheeting which is overlapped and anchored.
- 4. Equipment maintenance practices a. If possible, equipment should be taken to off-site commercial facilities for washing and
- b. If performed on-site, vehicles shall be washed with high-pressure water spray without
- detergents in an area contained by an impervious berm. Drip pans shall be used for all equipment maintenance.
- Equipment shall be inspected for leaks on a daily basis.
- e. Washout from concrete trucks shall be disposed of in a temporary pit for hardening and proper disposal.
- f. Fuel nozzles shall be equipped with automatic shut-off valves. g. All used products such as oil, antifreeze, solvents and tires shall be disposed of in
- accordance with manufacturers' recommendations and local, state and federal laws and

5. Spill prevention practices

- a. Potential spill areas shall be identified and contained in covered areas with no connection b. Warning signs shall be posted in hazardous material storage areas.
- c. Preventive maintenance shall be performed on all tanks, valves, pumps, pipes and other
- equipment as necessary.

d. Low or non-toxic substances shall be prioritized for use.

Adapted from USEPA Pub. 840-B-92-002

DE-ESC-3.6.1 Sheet 4 of 5


Effective February 2019

Standard Detail & Specifications Concrete Mixing Operation

Construction Notes:

- Locate concrete mixing and containment area a minimum of 50 feet from open channels, stormdrain inlets, wetlands or waterbodies.
- 2. Locate concrete mixing and containment area so that it is accessible to telescopic lifts (service with a minimum 10 foot wide gravel or paved accessway), but so it is not in a highly active construction area causing accidental damage.
- backside using cement or sand bags, or keyed into the ground a minimum of 6".
- 5. Allow cementitious waste to harden through evaporation of the wastewater. Once the facility has reached 75 percent of its capacity, remove the hardened concrete by reusing the broken aggregate onsite, recycling, or disposing of offsite. The hardened material can
- 6. Apply a new liner before reusing the station for additional mixing after maintenance has

3. Minimum volume for installed containment areas are 3.5 cubic feet per cubic foot of mixing capacity. The installed containment area must encompass the storage silo and mixing unit, and be surround on three sides minimum by a 12" high stone berm (DE #57) or 4. The 10-mil poly liner must be free of tears or holes and placed over smooth surfaces to prevent puncturing. The liner shall cover the perimeter control and be secured on the be buried on site with minimum of I foot of clean, compacted fill. Adapted from DE-ESC-3.6.3 CMO MN/DOT Concrete Manual, Sheet 2 of 2 Chap. 4 Effective FEB 2019

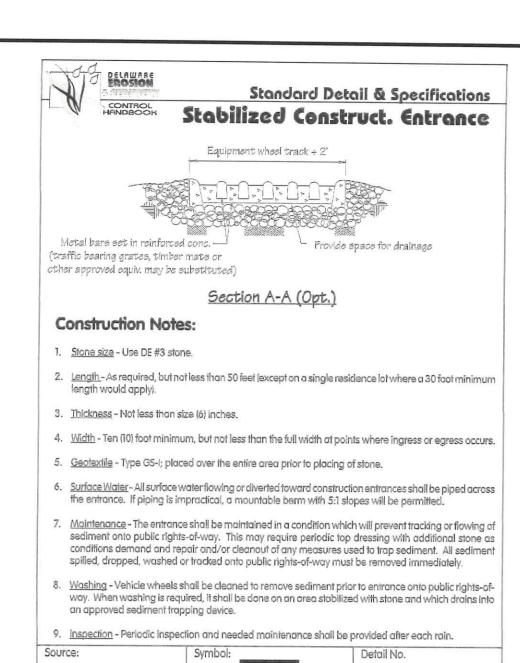

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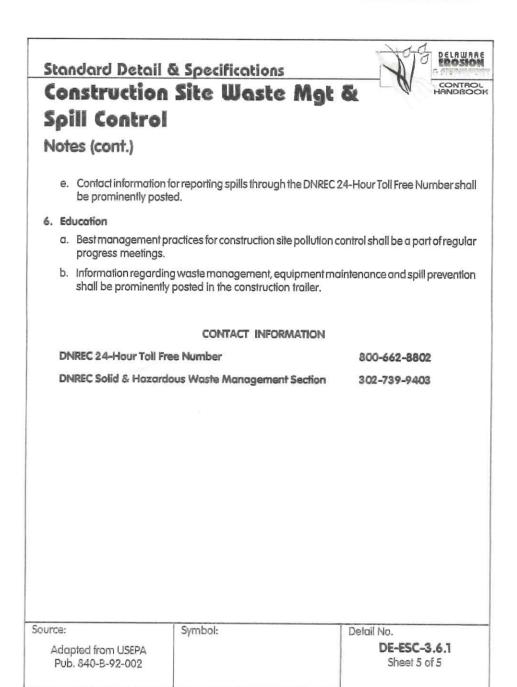
Adapted from

VA ESC Handbook

Effective February 2019


DE-ESC-3.4.7


Sheet 2 of 2




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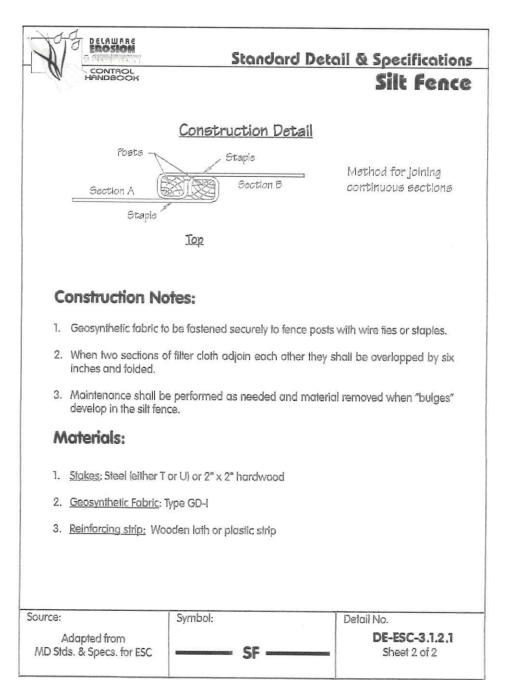


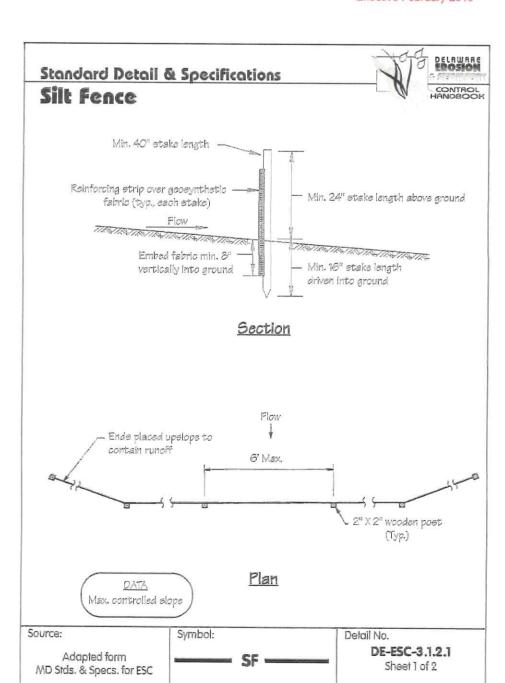


Effective February 2019

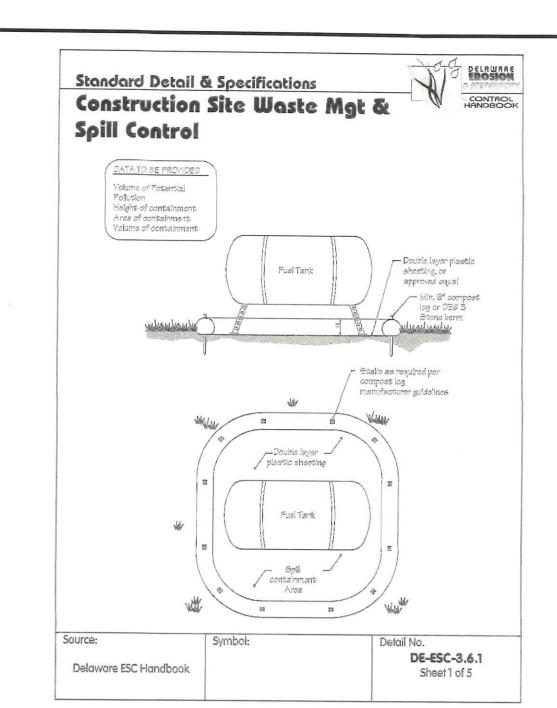

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2. Fueling must be with nozzles equipped with automatic shut-off to control drips. Do not top off. 3. Protect the areas where equipment or vehicles are being repaired, maintained, fueled or parked 4. Use barriers such as berms to prevent storm water run-on and runoff, and to contain spills.

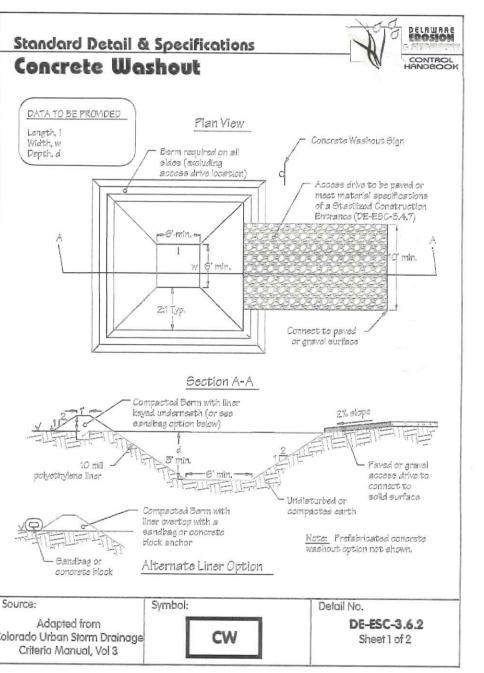7. Inspect vehicles and equipment for leaks on each day of use. Repair fluid and oil leaks 8. Absorbent spill clean-up materials and spill kits must be available in fueling areas and on fuel

9. If fueling is to take place at night, make sure the fueling area is sufficiently illuminated.

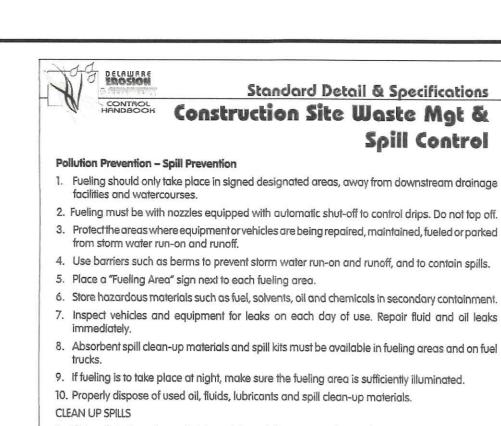1. If it is safe to do so, immediately contain and clean up any chemical and/or hazardous material

2. Properly dispose of used oil, fluids, lubricants and spill clean-up materials. 3. Do not bury spills or wash them down with water.

LEAKS AND DRIPS 1. Use drip pans or absorbent pads at all times. Place under and around leaky equipment.

2. Do not allow oil, grease, fuel or chemicals to drip onto the ground. Have spill kits and clean up material on-site.


4. Repair leaky equipment promptly or remove problem vehicles and equipment from the site. Clean up contaminated soil immediately.

5. Store contaminated waste in sealed containers constructed of suitable material. Label these containers properly.

Clean up all spills and leaks. Promptly dispose of waste and spent clean up materials. DE-ESC-3.6.1

Delaware ESC Handbook Sheet 2 of 5

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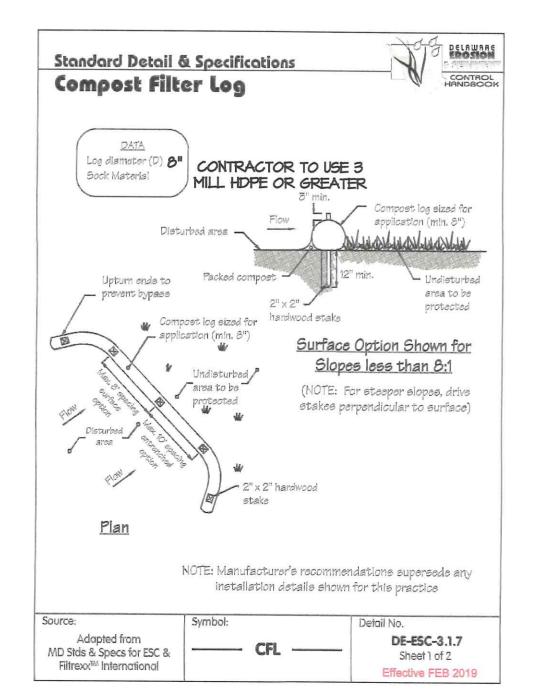

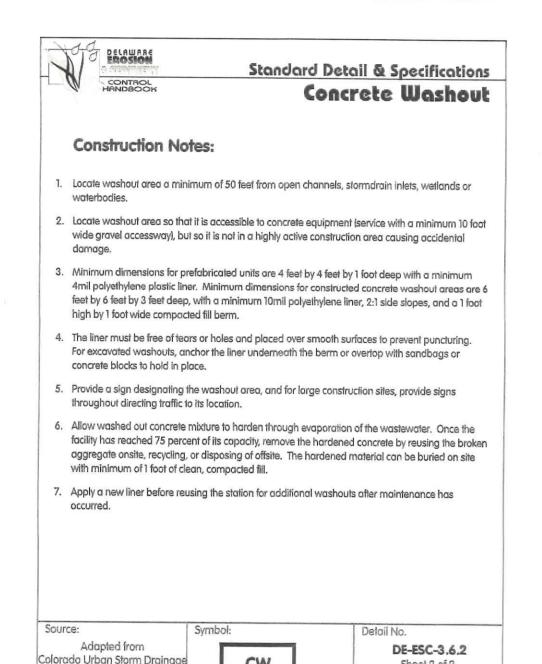
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Criteria Manual, Vol 3

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Sheet 2 of 2



Standard Detail & Specifications

Construction Site Waste Mgt & Spill Control

Notes:

The Construction Site Pollution Prevention Plan should include the following elements: Material Inventory

Document the storage and use of the following materials:

a. Concrete

- b. Defergents c. Paints (enamel and latex)
- d. Cleaning solvents
- e. Pesticides f. Wood scraps
- g. Fertilizers h. Petroleum based products
- 2. Good housekeeping practices
- a. Store only enough product required to do the job. b. All materials shall be stored in a neat, orderly manner in their original labeled containers
- Substances shall not be mixed.
- d. When possible, all of a product shall be used up prior to disposal of the container. e. Manufacturers' instructions for disposal shall be strictly adhered to.
- f. The site foreman shall designate someone to inspect all BMPs daily.


 Waste management practices a. All waste materials shall be collected and stored in securely lidded dumpsters in a location that does not drain to a waterbody.


b. Waste materials shall be salvaged and/or recycled whenever possible

c. The dumpsters shall be emptied a minimum of twice per week, or more if necessary. The licensed trash hauler is responsible for cleaning out dumpsters.

DE-ESC-3.6.1 Adapted from USEPA Pub. 840-B-92-002 Sheet 3 of 5

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Prior to installation, clear bedding area of obstructions including rocks or debris larger than 1 inch and fill in any sharp depression areas.

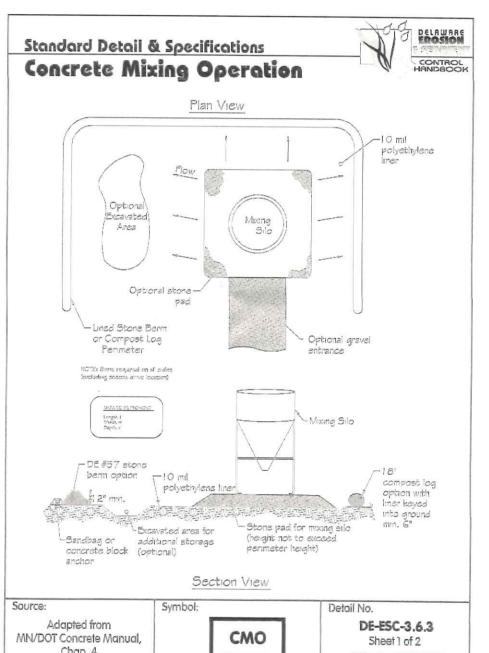2. If socks are prepared on-site, fill the sock fabric using a pneumatic blower so that the logs are rigid and do not deform. Terminate at the desired length.

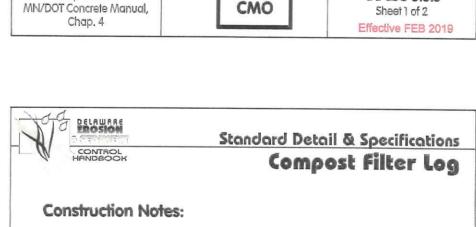3. For trenched applications, excavate 2 to 4 inches below grade along the width and length of the compost filter log. Install the compost filter logs perpendicular to the flow direction and parallel to the slope with the

beginning and end of the installation pointing up the slope a minimum of 1 foot elevation difference. On sites where this is not possible, upturn at a minimum length of 10' at a 30 degree angle to

5. For untrenched applications, blow or hand pack soil, mulch, or compost on the upslape side of the log, filling the bottom void area. 6. Stake the filled log every 10 feet maximum through the center of the sock for trenched applications,

or every 8 feet for untrenched. The stake shall be a 2" by 2" hardwood. It should extend 12" below grade and protrude at least 3" above the top of the sock. If located on a slope greater than 8:1, the stake shall be angled downslope at a 45 degree angle to prevent the force of the water from dislodging to log.

When the length of the compost filter log needed exceeds the available compost filter sock length, the next sock shall be overlapped a minimum of 12" before being filled, and a stake placed through both socks at the overlap.

8. Remove accumulated sediment when it has reached half of the effective height of the log.

9. Inspect weekly and after rain event. If sock is degrading or the sock is failing, vegetate to secure the compost, replace the log, or reinforce with an additional log. If the log has been crushed due to construction equipment, it can be "fluffed" back to its effective height. If the effective height can no longer be restored, the log shall be replaced or reinforced with an additional compost filter log.

DE-ESC-3.1.7


Sheet 2 of 2

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MD Stds & Specs for ESC & Filtrexx™ International

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> Checked by: **CWB**

CONSTRUCTION SITE STORMWATE MANAGEMENT DETAILS & NOTES BROOM SOLAR PARTNERS, LLC BROOM SOLAR PROJECT ACENT TO 32419 FRANKFORD SCHOOL FRANKFORD, DELAWARE 19945

Contract No:

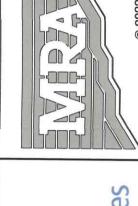05/31/2022

Sheet: SWM MAN. DETAIL

376627 Scale: N/A Date:

Drawing No: 3 OF 6 2. THE LOCATION OF UNDERGROUND UTILITIES AS INDICATED ON PLANS HAS BEEN OBTAINED FROM EXISTING RECORDS. NEITHER THE OWNER OR THE ARCHITECT/ENGINEER ASSUMES ANY RESPONSIBILITY WHATEVER IN RESPECT TO ACCURACY, COMPLETENESS, OR SUFFICIENCY OF THE INFORMATION SHOWN. THERE IS NO GUARANTEE, EITHER EXPRESSED OR IMPLIED THAT THE LOCATIONS, SIZE AND TYPE OF MATERIALS OF EXISTING UNDERGROUND UTILITIES INDICATED ARE REPRESENTATIVE OF THOSE TO BE ENCOUNTERED DURING CONSTRUCTION. IT SHALL BE THE CONTRACTOR'S RESPONSIBILITY TO DETERMINE THE ACTUAL LOCATION OF ALL SUCH UTILITIES, INCLUDING SERVICE CONNECTIONS TO UNDERGROUND UTILITIES. PRIOR TO CONSTRUCTION, THE CONTRACTOR SHALL NOTIFY THE OWNER OF THEIR OPERATIONAL PLANS. IN THE EVENT OF AN UNEXPECTED UTILITY INTERFERENCE DURING CONSTRUCTION, THE CONTRACTOR SHALL IMMEDIATELY NOTIFY THE OWNER.

ANY SUCH MAINS AND/OR SERVICES DISTURBED BY THE CONTRACTOR'S OPERATIONS SHALL BE RESTORED IMMEDIATELY AT THEIR EXPENSE. 3. PRIOR TO PERFORMING ANY EXCAVATION GREATER THAN 6 INCHES, THE CONTRACTOR SHALL COORDINATE WITH THE TOWN OF FRANKFORD AND ALL PRIVATE UTILITY COMPANIES TO DETERMINE THE LOCATION OF UNDERGROUND UTILITY LINES. THE CONTRACTOR SHALL BE RESPONSIBLE FOR COORDINATING WITH ALL ORGANIZATIONS THAT CONTROL EXISTING UNDERGROUND UTILITIES IN THE CONSTRUCTION AREA OR WOULD BE AFFECTED BY CONSTRUCTION WORK AROUND THE EXISTING UTILITIES.

4. THE CONTRACTOR SHALL NOT START EXCAYATION UNTIL ALL UTILITY LINE LOCATIONS HAVE BEEN STAKED OR OTHERWISE CLEARLY MARKED AND DOCUMENTATION FURNISHED TO THE OWNER. ALL MARKINGS SHALL BE CONSIDERED APPROXIMATE, AND UTILITIES OTHER THAN THOSE SHOWN SHALL BE CONSIDERED TO EXIST.

5. THE CONTRACTOR SHALL BE RESPONSIBLE FOR THE DEFINITE LOCATION OF EACH UTILITY WITHIN THE WORK AREA. CARE SHOULD BE EXERCISED DURING EXCAVATION WORK TO AVOID DAMAGING OR DISRUPTING UTILITIES. THE CONTRACTOR SHALL BE RESPONSIBLE FOR REPAIRING (AT CONTRACTOR'S EXPENSE) DAMAGE TO ANY UTILITY CAUSED BY THE CONTRACTOR'S WORK.

6. WHERE EXISTING UNDERGROUND UTILITIES OR OTHER CONSTRUCTION ARE EXPECTED TO BE IN PROXIMITY TO PROPOSED CONSTRUCTION, OR WHEN APPROACHING EXISTING UTILITIES OR STRUCTURES FOR CONNECTIONS, THE CONTRACTOR SHALL DIG TEST PITS TO DETERMINE THE EXACT LOCATION AND INVERTS OF THE EXISTING UTILITY TO ALLOW FOR POSSIBLE CHANGES TO THE PROPOSED UTILITY IN LINE AND/OR GRADE. THE CONTRACTOR SHALL ALSO DIG TEST PITS IN THE LOCATION OF THE PROPOSED CONNECTIONS TO EXISTING UTILITIES AND SHALL MAKE ALL MEASUREMENTS NECESSARY TO ENSURE PROPER CONNECTION. ANY NECESSARY CHANGES IN LINE OR GRADE OF WORK CAUSED BY FAILURE TO TAKE SUCH PRECAUTIONS SHALL BE AT THE EXPENSE OF THE CONTRACTOR.

7. WHEN IT IS NECESSARY TO EXCAVATE NEAR OR INTERFERE WITH ANY SEWER LINE, WATER SERVICES, DRAIN PIPE, CATCH BASIN, CULVERT, OR OTHER STRUCTURES, THE CONTRACTOR SHALL MAINTAIN THE SAME IN WORKING ORDER AND SHALL REPAIR AND MAKE GOOD ANY DAMAGE DONE DURING THE PROGRESS OF THE WORK.

6. WHERE EXISTING UTILITIES CROSS THE TRENCH EXCAYATION, THEY SHALL BE ADEQUATELY SUPPORTED AND PROTECTED FROM DAMAGE DUE TO CONSTRUCTION. ALL METHODS FOR SUPPORTING AND MAINTAINING THESE UTILITIES SHALL BE SUBJECT TO REVIEW BY OWNER. CARE SHALL BE TAKEN TO ENSURE THAT THE EXISTING UTILITY GRADES AND ALIGNMENT ARE MAINTAINED AND THE PIPE JOINTS ARE NOT DISTURBED. BACKFILL SHALL BE CAREFULLY PLACED AND TAMPED TO PREVENT DAMAGE OR FUTURE SETTLEMENT. ANY DAMAGE OR MISALIGNMENT OF THE UTILITIES DUE TO CONSTRUCTION OR SETTLEMENT SHALL BE REPAIRED BY THE CONTRACTOR AT THE CONTRACTOR'S EXPENSE.

9. ANY UNPROTECTED CABLE (DIRECT BURIED) ENCOUNTERED THAT IS VERIFIED AS NOT ABANDONED IN PLACE SHALL BE PROTECTED. THE UTILITY OWNER MAY DIRECT THE CABLE BE PLACED IN SPLIT DUCT OF APPROPRIATE SIZE AND CONCRETE ENCASED THROUGH THE AREA OF CONSTRUCTION. CONTRACTOR SHALL TAKE ALL REASONABLE MEASURES TO AVOID HAVING TO CUT AND

SPLICE DIRECT BURIED CABLE. THE CONTRACTOR SHALL NOTE SPLIT DUCT PORTIONS ON AS-BUILTS. 10. SHORING MAY BE REQUIRED TO PROTECT THE INTEGRITY OF THE ROADWAY IF TRENCH ENCROACHES WITHIN 5' OF PAVEMENT OR IF UNDERMINING OCCURS.

Standard Detail & Specifications Standard Detail & Specifications Mulching a. Apply product to geotechnically stable slopes that have been designed and constructed to Materials and Amounts divert runoff away from the face of the slope. b. Do not apply to saturated soils, or if precipitation is anticipated within 24-48 hours. a. Siraw - Straw shall be unrotted small grain straw applied at the rate of 1-1/2 to 2 tons per acre, or 70 to 90 c. During the spring (March 1 to May 31) and fall (September 1 to November 30) seasons, hydraulic pounds (two bales) per 1,000 square feet. Mulch materials shall be relatively free of weeds and shall be free mulches may be applied in a one-step process where all components are mixed together in of noxious weeds such as; thistles, Johnsongrass, and quackgrass. Spread mulch uniformly by hand or mechanically. For uniform distribution of hand spread mulch, divide area into approximately 1,000 square single-tank loads. It is recommended that the product be applied from opposing directions to achieve optimum soil coverage. feet sections and place 70-90 pounds (two bales) of mulch in each section. d. During the summer (June 1 to August 31) and winter (December 1 to February 28) seasons, the b. Wood chips - Apply at the rate of approximately 6 tons per acre or 275 pounds per 1,000 square feet when following two-step process is required: Step One-Mix and apply seed and soil amendments with a small amount of mulch for available and when feasible. These are parlicularly well suited for utility and road rights-of-way. If wood chips are used, increase the application rate of nitrogen fertilizer by 20 pounds of N per acre (200 pounds visual meterina. Step Two - Mix and apply mulch at manufacturers recommended rates over freshly of 10-10-10 or 66 pounds of 30-0-0 per acre).

achieved at temperatures exceeding 60°F (15°C). Curing times may be accelerated in high a. Wood fiber mulch shall consist of specially prepared wood that has been processed to a temperature, low humidity conditions on dry soils. uniform state, is packaged for sale as a hydraulic mulch for use with hydraulic seeding Recommended application rates are for informational purposes only. Conformance with this standard equipment, and consists of a minimum of 70% virgin or recycled wood fiber combined with and specification shall be performance-based and requires 100% soil coverage. Any areas with bare soil showing shall be top dressed until full coverage is achieved. Blended fiber mulch shall consist of any hydraulic mulch that contains greater than 30% paper Compost blanket (CB) - Loosely applied with a pneumatic blower so that a 1" compost blanket uniformly covers fiber. The paper component must consist of specially prepared paper that has been processed

the soil with 100% coverage. This application can be used with seed to promote germination by applying the approved seed mix directly into the loosely blown compost. The compost blanket performs best on slopes less than 2:1 and requires no mulch anchoring. c. A bonded fiber matrix (BFM) consists of long strand, specially prepared wood fibers that have Anchoring mulch - Mulch must be anchored immediately to minimize loss by wind or water. This may be done

by one of the following methods, depending upon size of area, erosion hazard, and cost. been processed to a uniform state held together by a water resistant bonding agent. BFMs Crimping - A crimper is a tractor drawn implement designed to punch and anchor mulch into the top two shall contain no paper (cellulose) mulch but may contain small percentages of synthetic fibers (2) inches of soil. This practice affords maximum erosion control but is limited to flatter slopes where equipment can operate safely. On sloping land, crimping should be done on the contour whenever

Tracking - Tracking is the process of cutting mulch (usually straw) into the soil using a buildozer or other equipment that runs on cleated tracks. Tracking is used primarily on slopes 3:1 or steeper and should be done up and down the slope with cleat marks running across the slope.

Liquid mulch binders - Applications of liquid mulch binders should be heavier at edges, in valleys, and at crests of banks and other areas where the mulch will be moved by wind or water. All other areas should have a uniform application of binder. The use of synthetic binders is the preferred method of mulch binding and should be applied at the rates recommended by the manufacturer.

Paper fiber - The fiber binder shall be applied at a net dry weight of 750 lbs/ac. The wood cellulose fiber shall be mixed with water, and the mixture shall contain a maximum of 50 lbs. of wood cellulose fiber per Nettings - Synthetic or organic nettings may be used to secure straw mulch. Install and secure according


to the manufacturers recommendations. Source: Delaware ESC Hand & Filtrexx™ Interna

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ndbook ational		DE-ESC-3.4.5 Sheet 2 of 3

seeded surfaces. Apply from opposing directions to achieve optimum soil coverage.

e. Minimum curing temperature is 40° F (4° C). The best results and more rapid curing are

Effective February 2019

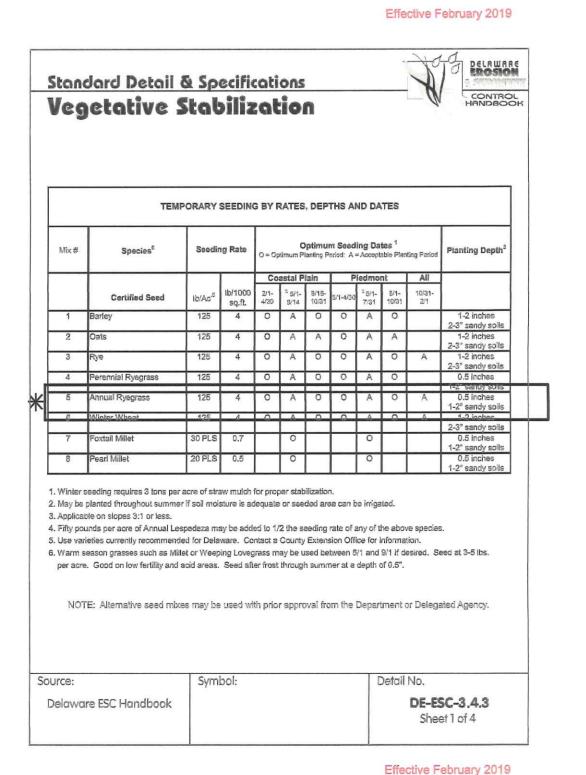

c. Hydraulically applied mulch-The following conditions apply to hydraulically applied mulch:

to a uniform fibrous state and is packaged for sale as a hydraulic mulch for use with hydraulic

d. Refer to Figure 3.4.5a for conditions and limitations of use for each of the above categories of

ii. All components of the hydraulically applied mulches shall be pre-packaged by the manufacturer to

iii. Hydraulic mulches shall be applied with a viable seed and at manufacturer's recommended rates.

iv. Materials within this category shall only be used when hydraulically applied mulch has been specified

for use on the approved Sediment and Stormwater Plan, or supplemental approval from the plan

DE-ESC-3.4.5

Sheet 1 of 3

per manufacturers recommendations to ensure the proper results.

Hydraulically applied mulches and additives shall be mixed (

approval agency has been obtained in writing for a specific area.

Increased rates may be necessary based on site conditions.

assure material performance. Field mixing of the mulch components is acceptable, but must be done

30% paper fiber and additives.

seeding equipment.

recommendation:

Delaware ESC Handbook

& Filtrexx™ International

to enhance performance.

Definitions

	Seeding Mixtures		n Potal	Г		Pamarka					
			ng Rate ¹	O = Optimum Planting Period A = Acceptable Planting Period							Remarks
Mix No.	Certified Seed ³		16/1000	2/1-	stal P	fain 8/15-	3/1-	iedmo	8/1-	All ^a	
1	Well Drained Soils	Ib/Ac 140	sq.ft. 3.2	4/30 A	8/14	10/31 A	4/30 A	7/31 O	10/31 A	10/31-2/1 Add 100	Good erosion control mix
	Weeping Lovegrass	10	0.23	Î	Ü	ĺ.	Ŷ	Ü	,	Ibs/ac Winter Rye	Tolerant of low fartility soils Lovegrass very difficult to mot Germinates only in hot weather
2	Deerlongue Sheep Fescue Common Lespedeza ⁵	30 30 15	0.69 0.69 0.35	Α	0	A	A	0	A	Add 100 lbs./ac Winter	Good erosion control mix Tolerant of low fertility soils Good wildlife cover and food
- 2	Tall Fescue (Turf-type) or	50	1.15	0	A	0	0	A	0	Add 100	Good erosion control mix
3	Strong Craeping Red Fescue or Perennial Ryagrass	50 50	1.15 1.15 1.15		A	0	J	A		fbs./sc. Winter Rve	Tall Fescue for droughly conditions. Creeping Red Fescue for heavy shade. Flatpe
	plus Flatpea®	15	0.34							nye	to suppress woody vegetation
	Kentucky Bluegrass Perennial Ryegrass or Redtop	70 15 5	1.61 0.35 0.11	-		-9-	-3-		-9-	lbs./ac. Winter Rye	Canada Bluegrass more drought tolerant. Use Redtop for increased
	plus White Clover ⁵	3	0.07								drought tolerance.
5	Switchgrass ^{c.7} or Coestal Panicgrass Big Bluestern Little Bluestern	10 10 5 5	0.23 0.23 0.11 0.11		0			0			Native warm-season mixture Tolerant of low fertility soils. Drought tolerant. Poor shade tolerance.
- 6	Indian Grass Tali Fescue (turf-type)	5 150	0.1 3.5	0	A	0	0	A	0		N fertilizer discouraged - week Managed filter strip for
- 7	(Blend of 3 cultivars)	150	3.5	0	. 68	0	0	5555	0		nutrient uptake.
	Ky. Bluegrass (Blend) Parannial Ryagrass	20 20	0.46 0.46		Α	0		A	0		Three cultivars of Kentucky Bluegrass, Traffic tolerant,
8	Big Bluestem" Indian Grass" Little Bluestem" Creeping Red Fescue plus ons of: Partridge Pes	10 10 8 30	0.23 0.23 0.16 0.69	0	A		0	A			All species are native. Indian Grass and Bluestern har fluffy seeds. Plant with a specialized native seed drill. Crasping Red Fescue will
	Bush Clover Wild Indigo Showy Tick-Trefoil	3 9 2	0.07 0.07 0.05								provide erosion protection whi line warm season grasses get established.

1	specialized native seed drill.	
	Crasping Red Fescue will provide erosion protection while the warm season grasses get established.	
artmen	or Delegated Agency.	
Deta	l No.	
	DE-ESC-3.4.3	
	Sheet 2 of 4	
1		
Effe	ective February 2019	

Mix No.	Seeding Mixtures	$\overline{}$		CEUIN	G AND	SEEL	MNG L	MILO	leour	.)	
	Cartified Seed ³	Seedir	ng Rate ¹		(O = Opt A = Acco	roum Ph	anting Pe	ripti		Remarks
9	<u> </u>	+	I By (# OOO		astal P	lain	Р	ledmo	nt	All ⁵	
Ð	Poorly Drained Solls	lb/Ac*	fb/1000 sq.ft.	2/1- 4/30	5/1- 8/14	10/31	3/1- 4/30	5/1- 7/31	8/1- 10/31	10/31-2/1 Add 100	0.43
	Rediop Creeping Bentgrass Sheep Fescue Rough Bluegrass	75 35 30 45	1.72 0.8 0.69	0	Λ	0	0	A	0	Ibs/ac. Winter Rve	Quick stabilization of disturbed aftes and waterway
10	Reed Canarygrass ⁰	10	0.23	Α		0	Α		0		Good erasion control, wildlift cover and wetland revegetation
	Residential Lawns			_	_			_	_		sover and metteria revegerally
11	Tall Fescue Perennial Ryagrass Kentucky Bluegrass Bland	100 25 30	2.3 0.57 0.69	0	Α	0	0	Α	0		High value, high maintenand light traffic, irrigation necessa Well drained soils, full sun.
12	Tall Fescue Perennial Ryegrass Sheep Fescue	100 25 25	2.3 0.57 0.57	0	А	0	0	А	0		Moderate value, low maintenance, traffic tolerant
13	Creeping Red Fescue Chewings Fescue Rough Bluegrass	50 50 20	1.15 1.15 0.4	0	A	0	0	А	0		Shade tolerant, moderate traffic tolerance, moderate maintenance.
14	Kentucky Bluegrass Creeping Red Fescue Rough Bluegrass or Chewings Fescue	50 90	0.4 1.15 2.1	0	А	a	0	А	0		Shade tolerant, moisture tolerant.
15	K-31 Tall Fescue	150	3,5	0	Α	0	0	Α	0		Monoculture, but performs w alone in lawns. Discourage
reflect loc 3. All seemaximum 4. Cool se 5. All legu 5. Warm 9 7. Warm 9	seeding requires 3 tons per acre (all conditions), de shall meet the minimum purity a 1% of weed seeds shall be in account of the seeds shall be in account of the seeds shall be in account of the seed must be incoulated, seeson grass mit; and Reed Consesson grass mit; and Reed Consesson grasses require a soil term	nd minimum ordance wit oughout sur ary Grass ca perature of	n germina th Section mmer if so annot be m at least 50	fion per 1, Chap il moist nowed i 0 degre	centag oter 24, ure is a more th es in or	es recoi Trile 3 (dequate an 4 tim der to g	mmend of the D or see es per ermina	led by to belawar eded an year. te, and	he Dela e Code ea can will ren	ware Depa be irrigated	ntment of Agriculture. The . nt until then.

SEQUENCE OF CONSTRUCTION

I. NOTIFY THE SUSSEX CONSERVATION DISTRICT (SCD) SEDIMENT AND STORMWATER PROGRAM IN WRITING AT LEAST FIVE (5) DAYS PRIOR TO THE START OF CONSTRUCTION. FAILURE TO DO SO CONSTITUTES A VIOLATION OF THE APPROVED SEDIMENT AND STORMWATER MANAGEMENT PLAN.

2. PRIOR TO ANY CLEARING, INSTALLATION OF SEDIMENT CONTROL MEASURES OR GRADING, A PRE-CONSTRUCTION MEETING MUST BE SCHEDULED AND CONDUCTED WITH THE AGENCY CONSTRUCTION SITE REVIEWER. THE

LANDOWNER/DEVELOPER, CONTRACTOR, AND CERTIFIED CONSTRUCTION REVIEWER ARE REQUIRED TO BE IN ATTENDANCE AT THE PRE-CONSTRUCTION MEETING; THE DESIGNER IS RECOMMENDED TO ATTEND.

INSTALL STABILIZED CONSTRUCTION ENTRANCE. CLEAR AND GRUB SITE FOR INSTALLATION OF SEDIMENT CONTROLS. CONTRACTOR SHALL INSTALL COMPOST FILTER LOGS AS SHOWN ON THE CONSTRUCTION SITE STORMWATER MANAGEMENT PLAN AND IMMEDIATELY REPAIR ANY DAMAGE TO THE COMPOST FILTER LOGS.

ALL PERIMETER CONTROLS ARE TO BE REVIEWED BY THE AGENCY CONSTRUCTION SITE REVIEWER AND APPROVED PRIOR TO PROCEEDING WITH FURTHER SITE DISTURBANCE OR CONSTRUCTION.

CLEAR AND GRUB THE REMAINING AREAS OF THE SITE AS NECESSARY. PREPARE SUBGRADE AND CONSTRUCT PROPOSED GRAVEL DRIVEWAY. ANY IMPACTS TO AGRICULTURAL DITCHES OR INSTALLATION OF CULVERT FOR DRIVEWAYS SHALL BE DONE IN A WAY TO PREVENT TURBID DISCHARGE. ANY SEDIMENT CONTROLS DISTURBED BY DRIVEWAY AND SOLAR FIELD INSTALLATION SHALL BE REPAIRED AT THE END OF EACH DAY. STABILIZE ALL REMAINING DISTURBED AREAS.

BEST AVAILABLE TECHNOLOGY (BAT) SHALL BE EMPLOYED TO MANAGE TURBID DISCHARGES OF AGRICULTURE DITCH MODIFICATION IN ACCORDANCE WITH REQUIREMENTS OF 7 DEL.C. CH. 60 AND THE CURRENT DELAWARE CONSTRUCTION GENERAL PERMIT (CGP).

8. THE CONTRACTOR SHALL AT ALL TIMES PROTECT AGAINST SEDIMENT OR DEBRIS LADEN RUNOFF OR WIND FROM LEAVING THE SITE. PERIMETER CONTROLS SHOULD BE CHECKED DAILY AND ADJUSTED AND/OR REPAIRED TO FULLY CONTAIN AND CONTROL SEDIMENTATION ON THE SITE, ACCUMULATED SEDIMENT SHALL BE REMOVED WHEN IT HAS REACHED HALF OF THE EFFECTIVE CAPACITY OF THE CONTROL, IN ADDITION, THE CONTRACTOR MAY NEED TO ADJUST OR REPAIR MEASURES IN TIMES OF ADVERSE WEATHER CONDITIONS, OR AS DIRECTED BY THE AGENCY CONSTRUCTION SITE REVIEWER.

THE CONTRACTOR IS TO DETERMINE IF ANY AGRICULTURAL DITCH MODIFICATIONS (FILL AND/OR PIPE INSTALLATION) AND PERFORM ANY NECESSARY WORK.

INSTALL SOLAR PANELS AND UNDERGROUND ELECTRICAL FACILITIES. THESE PLANS ASSUME THE SOLAR PANELS CAN BE INSTALLED WITHOUT THE STRIPPING OF TOPSOIL OR EARTH DISTURBANCE WITHIN THE DESIGNATED "LIMITS OF WORK". IF EARTH DISTURBANCE IS OBSERVED DURING THIS ACTIVITY, PERIMETER CONTROLS SHOULD BE INSTALLED TO PREVENT SEDIMENT LADEN WATER FROM LEAVING THE LIMITS OF WORK.

THE TRENCHING AND INSTALLATION AND INSTALLATION OF ON-SITE ELECTRICAL INFRASTRUCTURE SHALL BE DONE SO THAT THOSE AREAS CAN BE BACKFILLED AT THE END OF EACH WORK DAY AND PERMANENTLY STABILIZED WITHIN TWO WORK DAYS OF BACKFILLING. IF THIS CAN NOT BE ACCOMPLISHED, SEDIMENT CONTROLS SHOULD BE IMPLEMENTED TO PREVENT SEDIMENT LADEN WATER FROM LEAVING

THE LIMITS OF WORK. NOTIFY THE PERSON RESPONSIBLE FOR STORMWATER SYSTEM CONSTRUCTION REVIEW AT LEAST THREE (3) DAYS PRIOR TO THE START OF THE STORMWATER SYSTEM CONSTRUCTION; STORMWATER FACILITIES MUST BE

REVIEWED THROUGHOUT THEIR CONSTRUCTION. AFTER SOLAR PANEL CONSTRUCTION HAS BEEN COMPLETED, THE CONTRACTOR SHALL VERIFY THE GRADING AND SEED THE GRASS FILTER STRIPS ALONG BOTH SIDES OF THE PROPOSED DRIVEWAY PER THE DETAILS

PROVIDED IN THESE PLANS.

PERMANENTLY STABILIZE THE REMAINDER OF THE SITE.

MULCHING MATERIAL SELECTION GUIDE

od Fiber @ 2000 lbs/ac. min.

3FM @ 3000 lbs/ac, min.

Straw @ 2 Tons/ac. Min.

BFM @ 3000-3500 lbs/ac, min

Nood Fiber @ 2000-2500 lbs/ac. r

Nood Fiber @ 2500-3000 lbs/ac. min

BFM @ 3500-4000 lbs/ac. min.

FM @ 3500-4000 lbs/ac, min

Wood Fiber @ 2500-3000 lbs/ac.

Straw @ 2 Tons/ac. min.

BFM @ 4000 lbs/ac. min.

Compost Blanket (CI

Straw @ 2 Tons/ac. min.***

abilization Matting*

BFM @ 4000-4500 lbs/ac. mi

OK = Acceptable to use during this time period

All application rates are minimums

xx = Not acceptable to use during this time period.

Straw @ 2 Tons/ac. min.

Straw @ 2 Tons/ac. min.

Straw @ 2 Tons/ac. min.

6% to 10.9%

11% to 24.9%


Type of Mulch / App. Rate Dec. 1 to Feb. 28(29) March 1 to May 31 June 1 to Aug. 31 Sept. 1 to Nov. 30

* Note: Manufacturers Recommended Rates for informational purposes only. Performance standard requires 100% soil coverage.

**Note: Straw applied on slopes greater than 33% must be netted (this does not apply to topsoil stockpiles)

EROSION AND SEDIMENT CONTROL DEVICES SHOULD BE REMOVED ONLY AFTER WORK IN AN AREA HAS BEEN COMPLETED AND STABILIZED, WITH WRITTEN APPROVAL FROM THE AGENCY CONSTRUCTION SITE REVIEWER.

THE TERMINATION OF THE CONSTRUCTION GENERAL PERMIT WILL REQUIRE SUBMISSION AND ACCEPTANCE OF THE POST CONSTRUCTION VERIFICATION DOCUMENTS, INCLUDING FINAL STABILIZATION THROUGHOUT THE SITE, ALL ELEMENTS OF THE SEDIMENT AND STORMWATER MANAGEMENT PLAN IMPLEMENTED, AND ACCEPTANCE OF THE FINAL OPERATION AND MAINTENANCE PLAN.

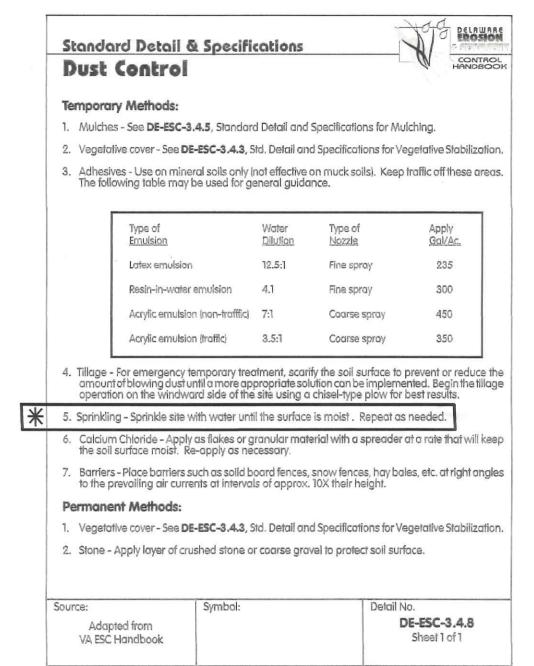

* PREFERRED METHOD

Effective February 2019

Effective February 2019

1	1	DELAWARE	Standard Deta	il & Specifications		
- (W	CONTROL		Stabilization		
C	on	struction Note	es:			
	Site	Preparation				
	a.		l needed erosion and sediment control pro s, berms, dikes, grassed waterways, and s			
	b.	Final grading and sha	ping is not necessary for temporary seedi	ngs.		
2.	See	edbed Preparation				
	see	dbed should be well pre	a good seedbed to insure the success of pared, loose, uniform, and free of large clood should not be compacted or crusted.			
3.	Soi	Amendments				
	a.	the approved nutrient	aterials based on the recommendations of management plan. If a nutrient manager the rate of 1 to 2 tons per acre. Apply lime les of soil.	ment plan is not required, apply		
	b.	approved nutrient mo	zer based on the recommendations of a s inagement plan. If a nutrient manageme at the rate of 600 pounds per acre. Apply to les of soils.	ent plan is not required, apply a		
4.	See	eding				
	a.	select a mixture from t	zation, select a mixture from Sheet 1 . I Sheet 2 or Sheet 3 depending on the cor or approval from the Department or Deleg	nditions. Alternative seed mixes		
	 Apply seed uniformly with a broadcast seeder, drill, cultipacker seeder or hydroseeder. All see will be applied at the recommended rate and planting depth. 					
	c.	into place using a rol	oadcast should be covered by raking or di ler or cultipacker. If hydroseeding is use nixed on site and the seeding shall be	d and the seed and fertilizer is		
5.	Mu	lching				
	All	mulching shall be done	e in accordance with detail DE-ESC-3.4.5			
our	ce:		Symbol:	Detail No.		
De	law	are ESC Handbook		DE-ESC-3.4.3 Sheet 4 of 4		

Drawn by:

Revisions:

No. Date:

P-000-5

Arbor, e: 734

Design by: CWB

Checked by:

DETAILS & NOTES
PARTNERS, LLC
AR PROJECT

Contract No: 376627 Scale: 05/31/2022


Drawing No: 4 OF 6

SWM MAN. DETAIL

Sheet:

* PREFERRED SEED MIX

* PREFERRED SEED MIX

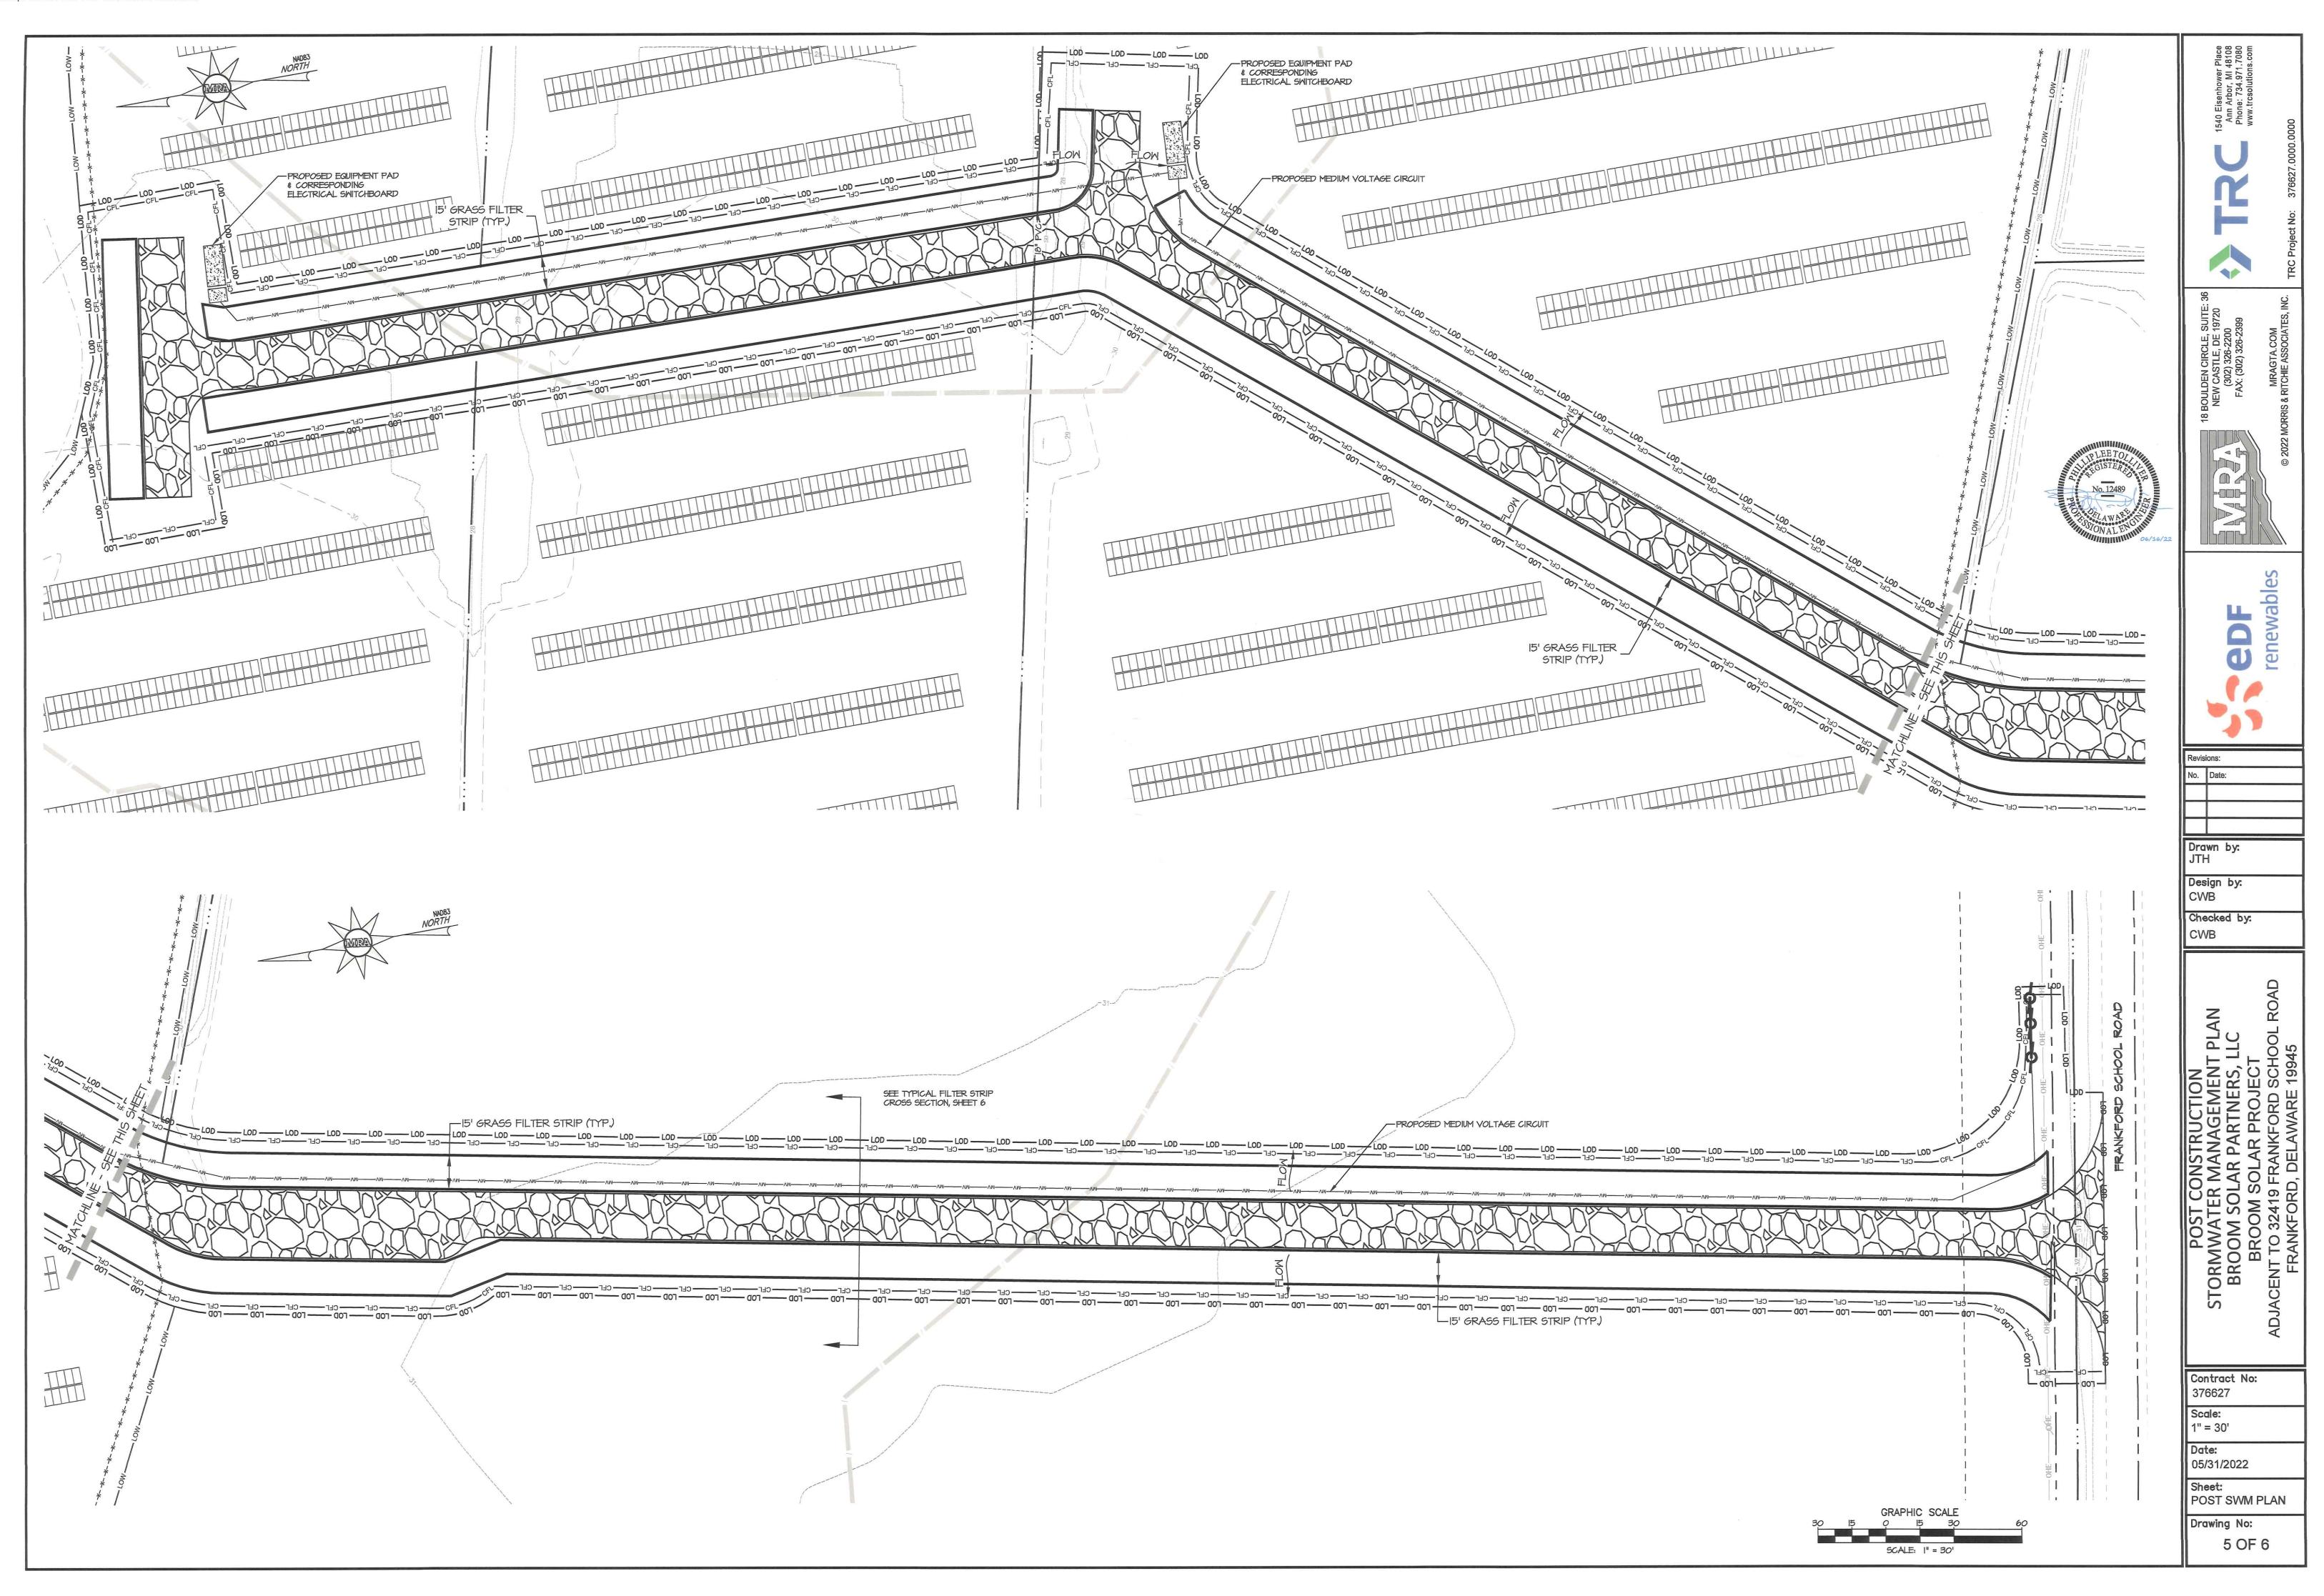

OPERATION AND MAINTENANCE NOTES


- THE OWNER IS TO OPERATE AND MAINTAIN EACH POST CONSTRUCTION STORMWATER MANAGEMENT FACILITY. THE DIREC SEDIMENT AND STORMWATER PROGRAM AND/OR THE SUSSEX CONSERVATION DISTRICT (SCD), RESERVES THE
- RIGHT TO ENTER PRIVATE PROPERTY FOR PURPOSES OF PERIODIC SITE REVIEWS.

 THE SCD SHALL BE NOTIFIED WITHIN 30 BUSINESS DAYS IF THE PROPERTY OWNERSHIP IS TRANSFERRED TO A NEW
- THE DNREC SEDIMENT AND STORMWATER PROGRAM AND/OR THE SCD MAY SEEK ENFORCEMENT ACTION AGAINST ANY OWNER DEEMED NEGLIGENT IN FULFILLING THE OPERATION AND MAINTENANCE REQUIREMENTS OF THE DELAWARE
- SEDIMENT AND STORMWATER REGULATIONS. THE SCD SHALL BE CONTACTED IF A CONCERN ARISES REGARDING A STORMWATER MANAGEMENT FACILITY, BEFORE
- ANY NON-ROUTINE MAINTENANCE, OR IF MODIFICATIONS TO THE FACILITY ARE DESIRED. ANY DESIGN MODIFICATIONS MADE TO THE STORMWATER SYSTEM SHALL REQUIRE THE CREATION OF A NEW POST CONSTRUCTION STORMWATER MANAGEMENT PLAN AND/OR OPERATIONS AND MAINTENANCE PLAN, WITH APPROVAL OF THE PLAN(S) BY THE SCD.
- 6. FOR ALL STORMWATER EASEMENT AREAS (I.E., ACCESS, MAINTENANCE, OR OFFSITE) AND THE MINIMUM 15-FOOT WIDE ACCESSWAYS TO ALL STORMWATER FACILITIES AND THEIR STRUCTURAL COMPONENTS, REGULAR MOWING SHALL BE PERFORMED TO KEEP THE GRASS 6" OR LESS; NO TREES OR SHRUBS SHALL BE PLANTED, AND ANY FOUND GROWING SHALL BE REMOVED; AND NO PERMANENT STRUCTURES, SUCH AS FENCES OR SHEDS, SHALL BE LOCATED WITHIN THE EASEMENT OR ACCESSIVAY.
- WHEN THE FACILITY IS EXCAVATED TO REMOVE ACCUMULATED SEDIMENT, THE DISPOSAL AREA SHALL BE PERMANENTLY STABILIZED SO THAT IT DOES NOT RECREATE AN EROSION PROBLEM. ANY MATERIAL TAKEN
- OFF-SITE SHALL STILL BE UTILIZED OR DISPOSED OF IN AN APPROVED DIREC MANNER. BEFORE ANY EARTHWORK OR EXCAVATION TAKES PLACE, THE CONTRACTOR SHALL CALL MISS UTILITY AT 811 OR 1.800.282.8555 AT LEAST 48 HOURS PRIOR TO CONSTRUCTION, TO HAVE ALL EXISTING UTILITIES MARKED ONSITE.

SHEET FLOW TO FILTER STRIP OR OPEN SPACE MAINTENANCE ITEMS	AND FREQUENCY
MAINTENANCE ACTIVITY	SCHEDULE
INSPECT THE SITE AFTER STORM EVENT THAT EXCEEDS 0.5 INCHES OF RAINFALL. STABILIZE ANY BARE OR ERODING AREAS. WATER TREES AND SHRUBS-DURING THE FIRST GROWING SEASON. IN GENERAL, WATER EVERY 3 DAYS FOR THE FIRST MONTH, AND THEN WEEKLY DURING THE REMAINDER OF THE FIRST GROWING SEASON (APRIL - OCTOBER), DEPENDING ON RAINFALL.	DURING ESTABLISHMENT, AS NEEDED (FIRST YEAR)
REPAIR-ERODED, AND/OR BARE SOIL AREAS.	QUARTERLY OR AFTER MAJOR STORMS (>I INCH OF RAINFALL)
MOWING OF THE GRASSED FILTER STRIP OF GRASSED OPEN SPACE. INSPECT AND TREAT FOR INVASIVE SPECIES AS NEEDED.	TWICE A YEAR
REMOVE TRASH AND DEBRIS. A FULL MAINTENANCE REVIEW.	ANNUALLY





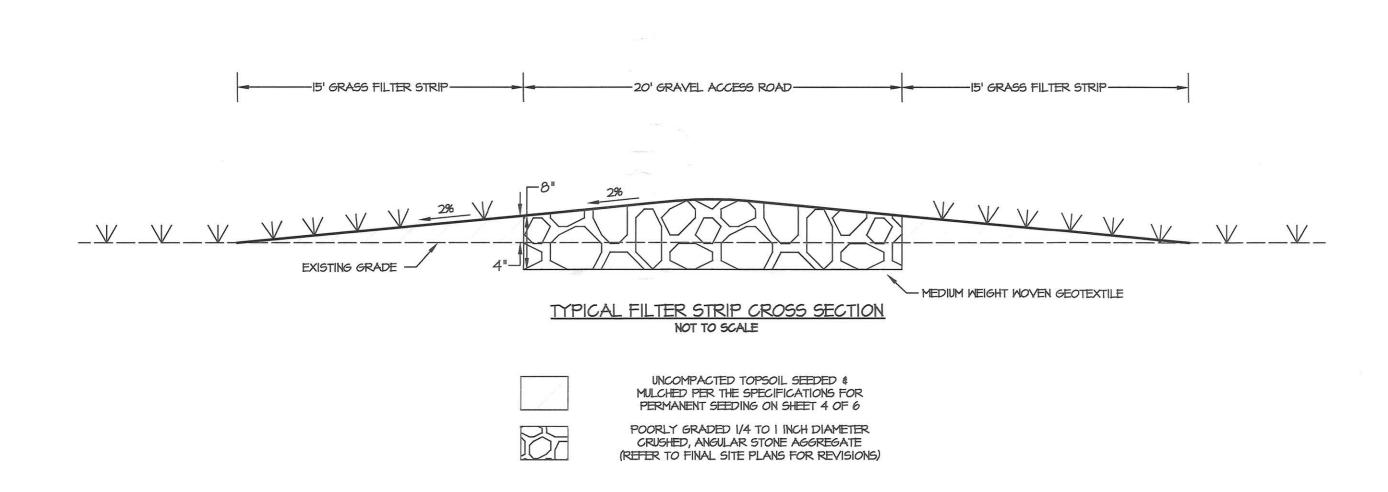





No. Date:

Drawn by:

Design by: **CWB**

Checked by:

CWB

BROOI BRC


Contract No: 376627


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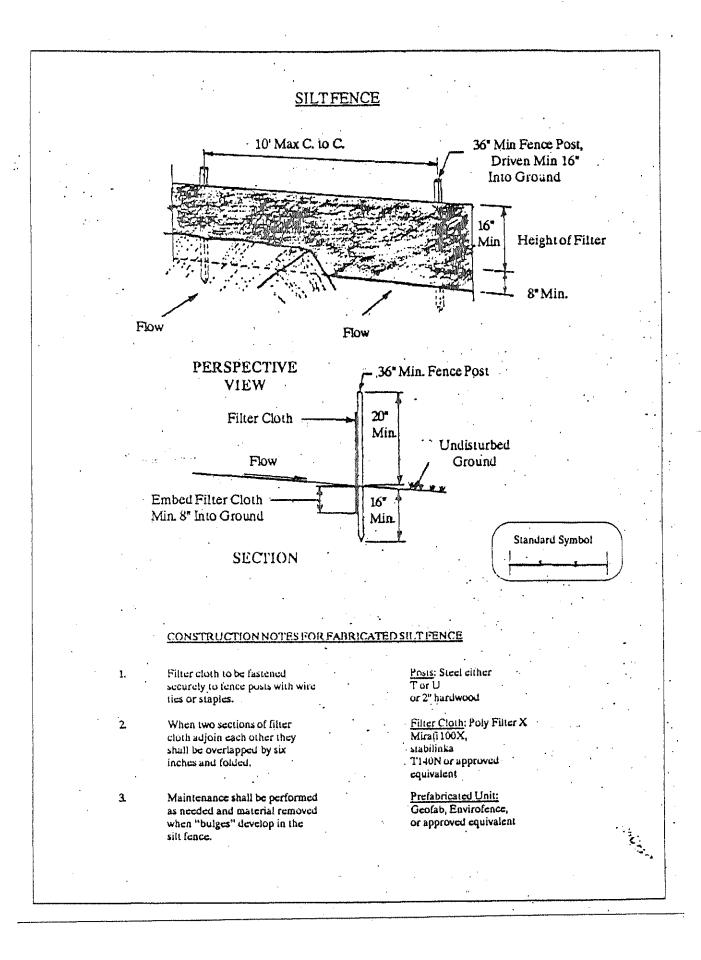
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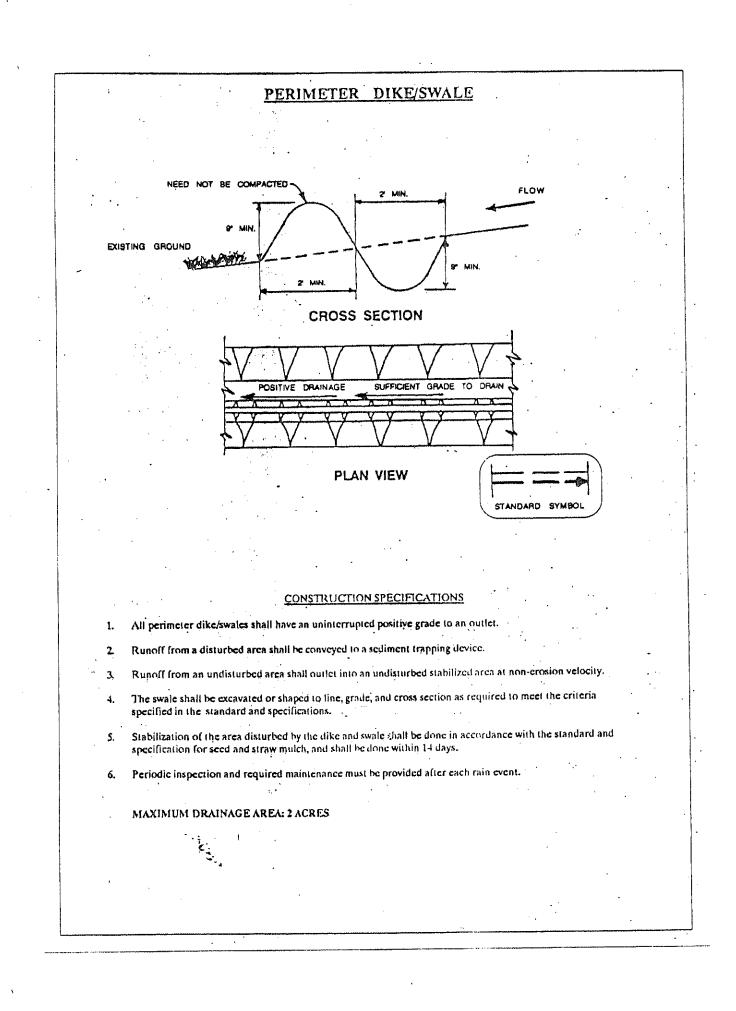
Sheet: POST SWM DET.


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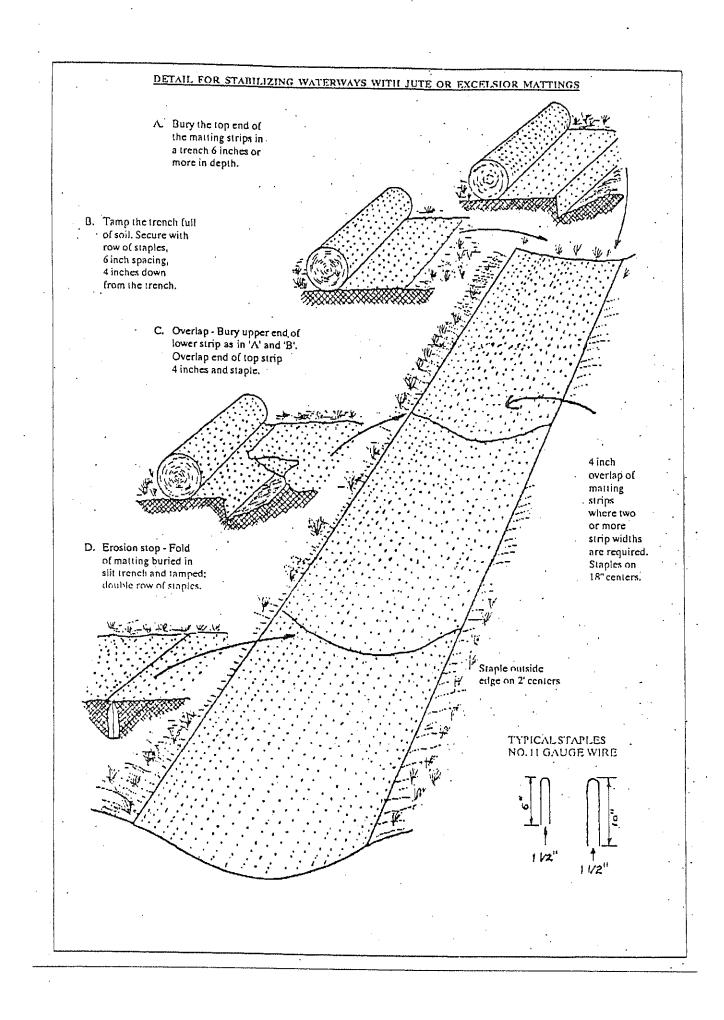







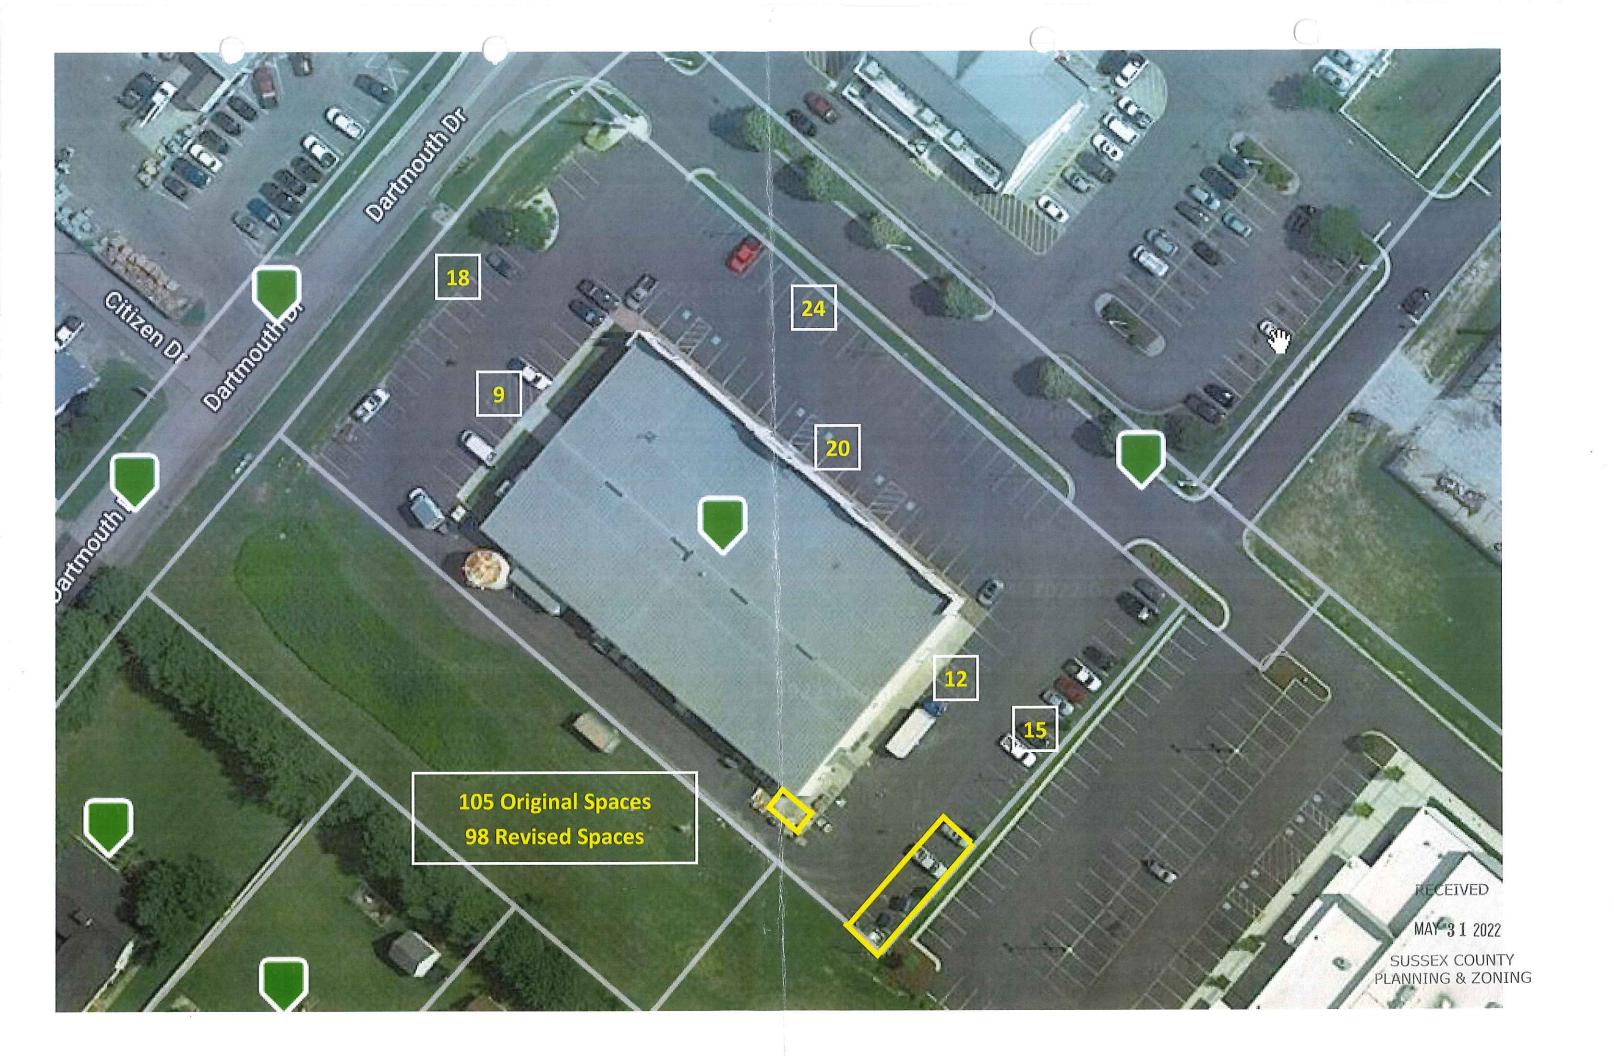

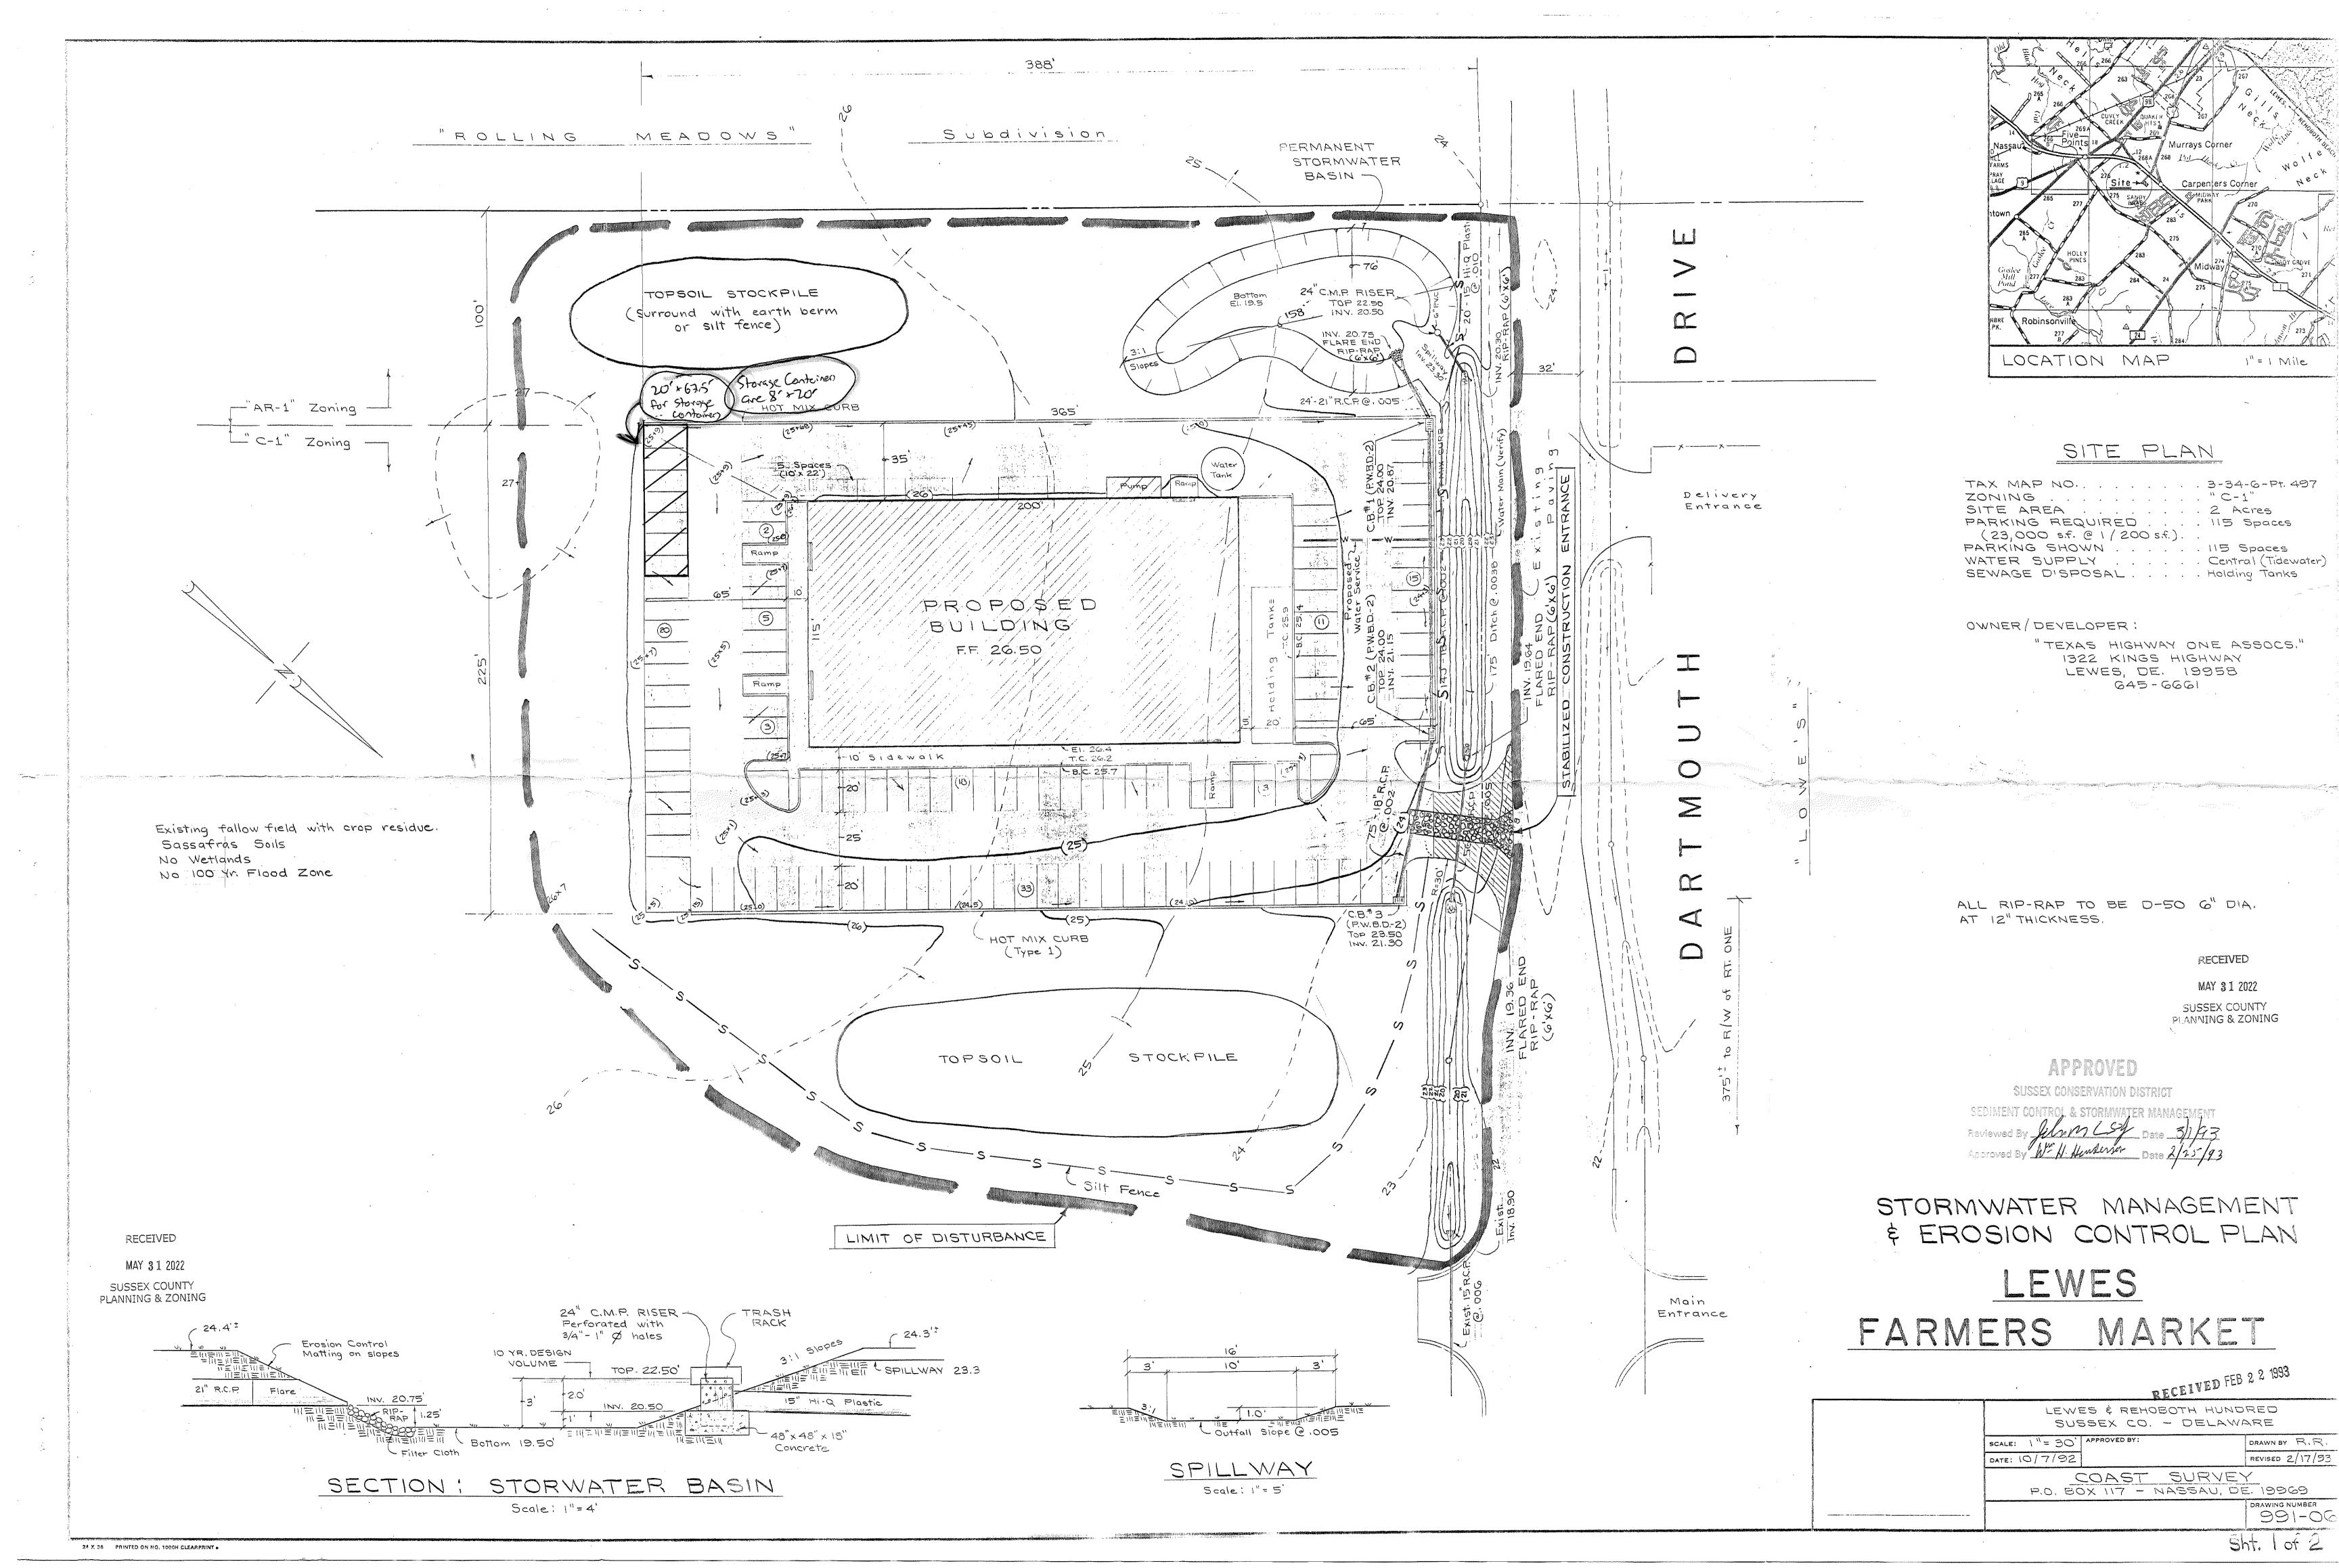

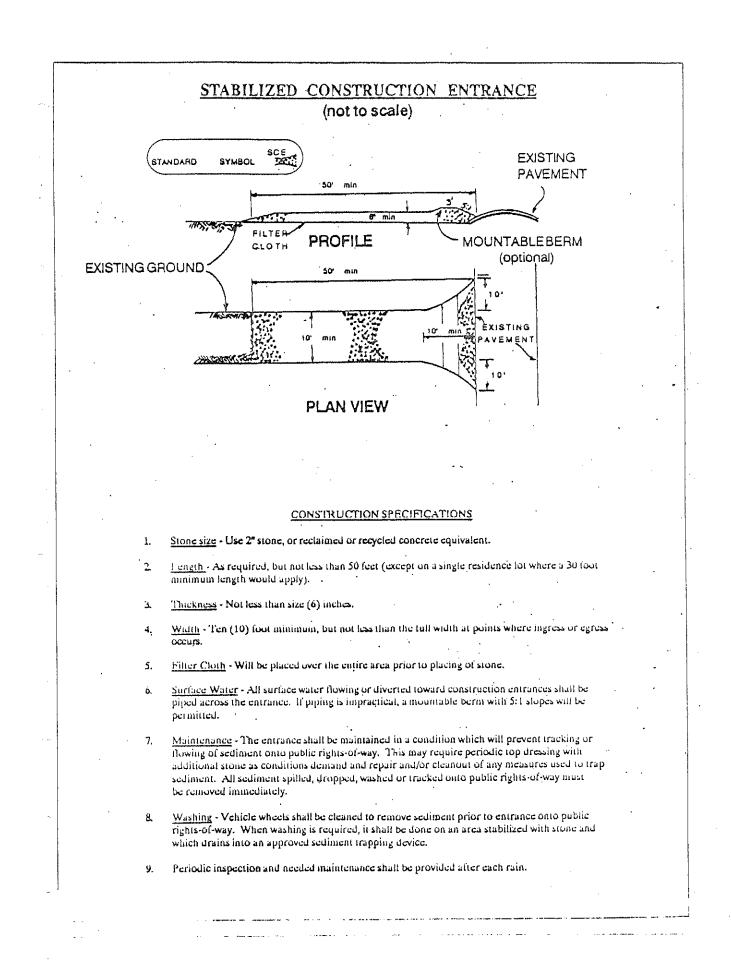

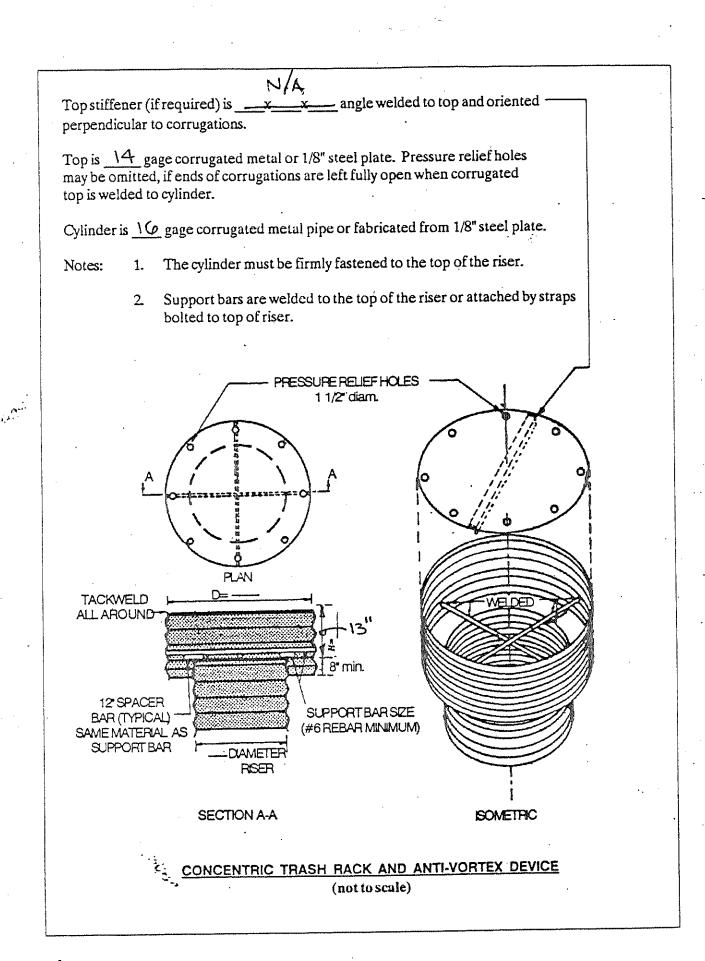

1.) Following soil disturbance or redisturbance, permanent or temporary stabilization shall be completed within 14 calendar days as to the surface of all perimeter sediment controls, topsoil stockpiles, and all other disturbed or graded areas on the project site.

2.) Sussex Conservation District must be notified in writting five (5) days prior to commencing with construction. Failure to do so constitutes a violation of the

approved sediment and stormwater management plan.

3.) Review and or approval of the Sediment and Stormwater

Management Plan shall not relieve the contractor from his
or her responsibilities for compliance with the requirements
of the Sediment and Stormwater Regulations, nor shall it
relieve the contractor from errors or omissions in the
approved plan.

4.) If the approved plan needs to be modified, additional sediment and stormwater control measures may be required

as deemed necessary by the Sussex Conservation District.

5.) If dust control becomes a problem, water sprinkling

shall be employed.

6.) General contractor to be responsible for maintenance and repair of all erosion and sediment control and storm-water management practices damaged during utility install-ation.

7.) Property owners shall be responsible for the perpetual maintenance of the stormwater management facilities

PERMANENT SEEDING

Seed - Kentucky 31 Tall Fescue @5-6 lbs./1,000 s.f. Fertilizer - 10-10-10 @46 lbs./1,000 s.f. Straw Mulch @92 lbs./1,000 s.f. Lime @92 lbs./1,000 s.f.

TEMPORARY SEEDING

Seed - Ryagrass @1 1b./1,000 s.f. Fertilizer - 10-10-10 @14 1bs./1,000 s.f. Strau Mulch - @70-90 1bs./1,000 s.f. Lime - @46 1bs./1,000 s.f.

CONSTRUCTION SEQUENCE

- Install entrance drainage pipe with rip-rap & stabilized construction entrance.
- Construct permanent stormwater basin. Install catchbasins, pipes, riser, etc. Surround catchbasin with silt fence. Permanently seed stormwater basin.
- 3. Grade ditches along Dartmouth Drive & apply permanent seed-ing. Use erosion control matting.
- Strip, grade building area. Construct foundation, pour slab.
 Strip, cut/fill parking area to subgrade. Surround west topsoil stockpile with silt fence or berm and apply temporary seeding.
- 6. Construct curb, sidewalks, ramps around building.7. Lay stone base for parking. Pave.

8. Remove topsoil stockpile. Finish grade all disturbed areas & apply permanent seeding.

OWNER'S CERTIFICATION

I, the undersigned, certify that all land clearing, construction and development shall be done pursuant to the approved plan.


Salvatore Gallo

1322 Kings Highway
Lewes DR 19958

STORMWATER MANAGEMENT \$ EROSION CONTROL PLAN

LEWES
FARMERS MARKET

991-06

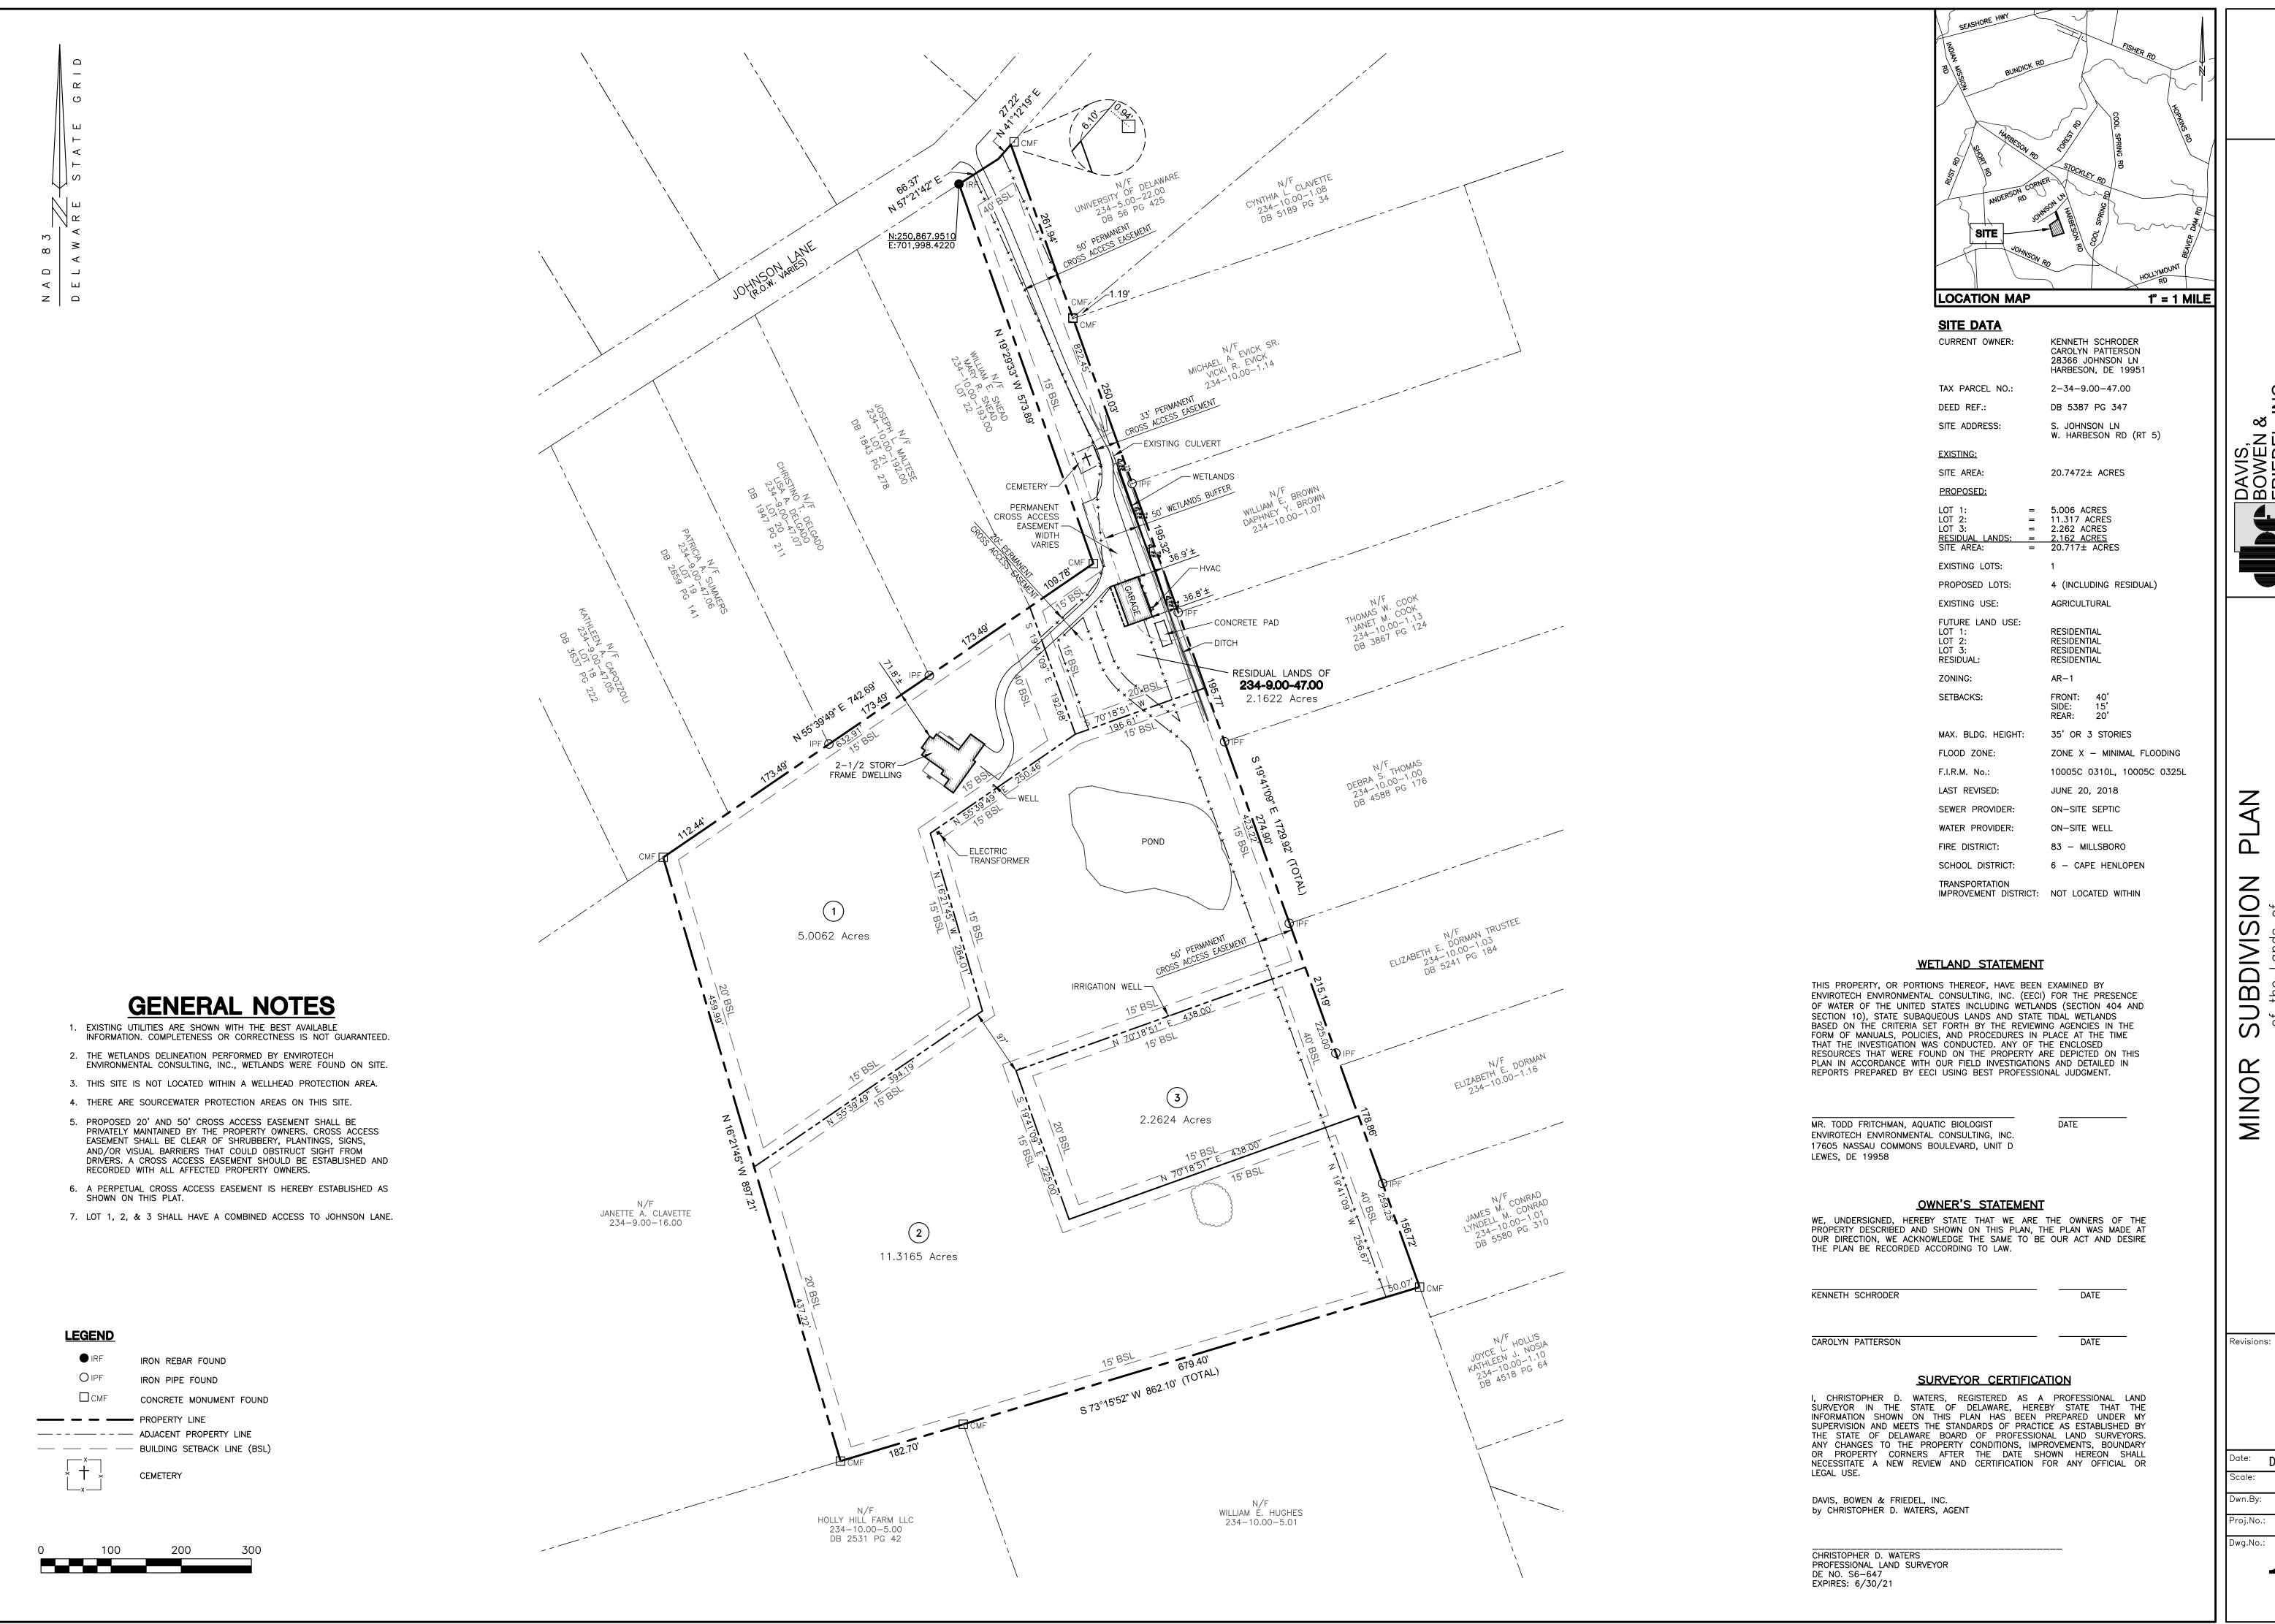

NO S FR

DECEMBER 2021

1"=100'

PAB

4037A001

OF

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